255 EAST HOUSTON ST.

MANHATTAN, N.Y. 10002

OWNER:

255 E HOUSTON MANAGER LLC

185 GREAT NECK ROAD, SUITE 250 GREAT NECK, NY 11021 (516) 487-5690

ARCHITECT:

THE STEPHEN B. JACOBS GROUP, P.C.

381 PARK AVENUE SOUTH NEW YORK, NY 10016 (212) 421-3712

STRUCTURAL ENGINEER:

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STRUCTURAL ENGINEERS
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MEP & FP ENGINEER:

SIDERIS KEFALAS
ENGINEERS PC
217-22 NORTHERN BOULEVARD, SUITE 1
BAYSIDE, NY 11361
(718) 224-9091



SCHEDULE OF DRAWINGS:

ARCHITECTURAL • • Z-110.00 I.H. CHARTS, ZONING BLDG. SECT. & AXON. DIAG. Z-111.00 ZFA, LOT COVERAGE & DENSITY DIAGRAMS BY ZONING DISTRICT A-010.00 SITE PLAN • • A-011.00 INITIAL SURVEY A-020.00 2014 NEW YORK CITY BUILDING ANALYSIS A-040.00 UFAS MOBILITY & A/V IMPAIRED ADAPTABLE UNIT PLANS • • A-100.00 CELLAR FLOOR PLAN A-101.00 | 1ST FLOOR PLAN A-102.00 2ND FLOOR PLAN A-103.00 3RD - 7TH FLOOR PLAN A-104.00 8TH FLOOR PLAN A-105.00 9TH FLOOR PLAN A-106.00 10TH FLOOR PLAN A-107.00 11TH FLOOR PLAN A-108.00 | 12TH - 13TH FLOOR PLAN A-109.00 14TH FLOOR AMENITY & ROOFTOP TERRACE PLAN A-110.00 BULKHEAD & ROOF PLANS A-200.00 BUILDING ELEVATIONS - HOUSTON WING • • A-201.00 BUILDING ELEVATIONS - SUFFOLK WING A-540.00 FINISH, APPLIANCE & FIXTURE SCHEDULES A-610.00 KITCHEN TYPES A-611.00 KITCHEN TYPES A-612.00 KITCHEN TYPES A-613.00 KITCHEN TYPES A-620.00 BATHROOM TYPES A-621.00 BATHROOM TYPES

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Drawing Title:

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SEAL & SIGNATURE:

SEAL & SIGNATURE:

STERED ARCHITICATION

OF NEW 105

DATE: 08/14/2015
PROJECT#: 1446
DRAWING SCALE: AS NOTED
DRAWING NO:

T-000.00

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ZONING ANALYSIS: 255 EAST HOUSTON STREET / 171 SUFFOLK STREET MANHATTAN, N.Y. 10002

R7A -- SOUTHERN 26' OF LOT 54 ZONING DISTRICTS: **R8A** -- THE REMAINDER OF LOT 54 YES -- MANHATTAN 3 INCLUSIONARY HOUSING DESIGNATED AREA INCLUSIONARY HOUSING **DESIGNATION:** [BTWN. CHRISTIE ST. & PITT ST. & WITHIN100' OF EAST HOUSTON STREET] ZONING MAP: HISTORIC DISTRICT:


LANDMARK BUILDING :	NO
COMMUNITY DISTRICT :	MANHATTAN 5
COMMUNITY BOARD :	MANHATTAN COMMUNITY BOARD
LITTLE "E" DESIGNATION :	LOT 54: E-216 (11/19/2008) - AIR QUALITY, WINDOW WALL ATTENUATIOI & ALTERNATE VENTILATION
LANDMARK DESIGNATED BUILDINGS WITHIN 90'-0" RADIUS OF SITE, SUBJECT TO TPPN 10/88 :	ONE LPC-DESIGNATED BLDG. @ ± 80'-0" from LOT 59, S-W CORNER, LP#: LP-01440 "ANSHE SLONIM SYNAGOGUE" 172 NORFOLK STREET
M.T.A. / AMTRAK APPROVAL :	SITE > 200FT FROM SUBWAY - NOT REQ'D
OTHER PROGRAM :	T . B . D .
LOT AREA: LOT 54 R8A LOT 54 R7A	8,240 S.F. 2,603 S.F. R8A = 8,240 S.F. R7A = 2,603 S.F. (PER SURVEY DATED 12/05/2015)
TOTAL LOT AREA	8,240 + 2,603 = 10,843 S.F.


	SECTION	TITLE OF SECTION	ZONING REGULATION - SUMMARY	ALLOWED AND / OR REQUIRED	PROVIDED
USE GROUPS	ZR: 32-00	USE GROUPS	PERMITTED USE GROUPS: 1, 2, 3 & 4	SINGLE & MULTI-FAMILY RESIDENTIAL USES (BUNGALOW / SEMI-DETACHED, CONDOMINIUM / RENTAL), TRANSIENT RESIDENTIAL (HOTEL), AND COMMUNITY FACILITIES (SPORTS CLUB / SWIMMING POOL).	USE GRP. 2 - RESIDENTIAL , OK USE GRP. 4 - COMMUNITY FACILITY , OK
	ZR: 77-12	SPECIAL USE GROUP PROVISIONS FOR ZONING LOTS DIVIDED BY DISTRICT BOUNDARIES	THE APPLICABLE USE REGULATIONS, AS SET FORTH IN ARTICLE-II, CHAPTER 2, FOR EACH DISTRICT SHALL APPLY TO THE PORTION OF THE ZONING LOT LOCATED WITHIN SUCH DISTRICT.		COMPLIES, SEE ZONING CALCS ON Z-111, OK
F.A.R.	ZR: 23-153	RESIDENTIAL F.A.R. FOR QUALITY HOUSING BUILDINGS	R7A: MAX. RESIDENTIAL F.A.R. = 4.00	[2,603 x 4.00] = 10,412 Z.F.A.	PROVIDED = 10,305 S.F., OK ⊗
	ZR: 23-154	FLOOR AREA COMPENSATION IN MANDATORY INCLUSIONARY HOUSING DESIGNATED AREAS	R8A: MAX. RESIDENTIAL F.A.R. = 7.20 MANDATORY INCLUSIONARY HOUSING MAX. ALLOWABLE RESIDENTIAL F.A.R.	[8,240 x 7.20] = 59,328 Z.F.A. 10,412 + 59,328 = 69,740 Z.F.A	PROVIDED = 54,738 S.F., OK ❖ PROVIDED = 65,043 S.F., OK ❖
	ZR: 24-11	COMMUNITY FACILITY F.A.R. IN RESIDENTIAL DISTRICTS	R7A: MAX. COMMUNITY FACILITY F.A.R. = 4.00 R8A: MAX. COMMUNITY FACILITY F.A.R. = 6.50 MAX. ALLOWABLE COMMUNITY FACILITY F.A.R.	[2,603 x 4.00] = 10,412 S.F. [8,240 x 6.50] = 53,560 S.F. 10,412 + 53,560 = 63,972 S.F.	PROVIDED = 4,510 S.F., OK ≪
			TOTAL ALLOWABLE F.A.R.	= 69,740 S.F.	PROVIDED = 69,553 S.F., OK ⊗
LOT COVERAGE	ZR: 23-153	RESIDENTIAL LOT COVERAGE FOR QUALITY HOUSING BUILDINGS	R7A: MAX. INTERIOR LOT COVERAGE = 65% R8A: MAX. INTERIOR LOT COVERAGE = 70% R8A: MAX. CORNER LOT COVERAGE = 80%	$[2,603 \times 0.65]$ = 1,692 S.F. $[240 \times 0.70]$ = 168 S.F. $[8,000 \times 0.80]$ = 6,400 S.F.	PROVIDED = 1,653 S.F., OK
ZONING LOTS DIVIDED BY DISTRICT BOUNDARIES		SPECIAL PROVISIONS FOR ZONING LOTS DIVIDED BY DISTRICT BOUNDARIES	WHERE A ZONING LOT THAT DID NOT EXIST ON DECEMBER15, 1961, IS DIVIDED BY ONE OR MORE ZONING DISTRICT BOUNDARIES, EACH PORTION OF THE ZONING LOT SHALL BE REGULATED BY ALL THE PROVISIONS APPLICABLE TO THE DISTRICT IN WHICH IT IS LOCATED.		
BULK REGS.	ZR: 23-01	RESIDENTIAL BULK REGS.	FOR BUILDING OR OTHER STRUCTURE, OTHER THAN A COMMUNITY FACILITY BUILDING, OR COMMUNITY FACILITY PORTION OF A BUILDING USED FOR BOTH RESIDENTIAL AND COMMUNITY FACILITY USES. BULK REGS. OF ART. II, CH. 4 APPLY TO THE COMMUNITY FACILITY PORTION OF A BUILDING USED FOR BOTH RESIDENTIAL AND COMMUNITY FACILITY USES.		
	ZR: 24-01	COMMUNITY FACILITY BULK REGS.	FOR THE COMMUNITY FACILITY PORTION OF A BUILDING LOCATED IN A RESIDENCE DISTRICT WITH BOTH RESIDENTIAL AND COMMUNITY FACILITY USES. BULK REGS. OF ART. II, CH. 3 APPLY TO THE RESIDENTIAL PORTION OF A BUILDING USED FOR BOTH RESIDENTIAL AND COMMUNITY FACILITY USES.		
DENSITY	ZR: 23-22	MAXIMUM NUMBER OF DWELLING UNITS	MAX. NO OF DWELLING UNITS (D.U.) EQUALS THE MAX. ALLOWABLE RESIDENTIAL FLOOR AREA DIVIDED BY THE APPLICABLE DENSITY FACTOR	R7A FACTOR = 680 R8A FACTOR = 980	
	ZR: 23-24	BUILDINGS USED FOR PARTLY FOR NON-RESIDENTIAL USES	R7A: MAX. NUMBER OF DWELLING UNITS = [MAX. ALLOWABLE RES. FLR AREA - NON-RESIDENTIAL FLR. AREA] / 680 R8A: MAX. NUMBER OF DWELLING UNITS = [MAX. ALLOWABLE RES. FLR AREA - NON-RESIDENTIAL FLR. AREA] / 790	R7A (10,412 / 680) = 15 UNITS R8A (59,328 - 4,596) / 680)) = 80 UNITS	R7A: (2.36 x 6) + 0.523 = 14.683 UNITS, OK R8A: (7.64 x 6) -1 + 6.477 + 6 + (4 x 4) = 73.317 UNITS, OK TOTAL NO. OF D.U. = 14.683 + 73.317 = 88 UNITS
	ZR: 24-20	APPLICABILITY OF DENSITY REGULATIONS TO ZONING LOTS CONTAINING BOTH RESIDENTIAL & COMMUNITY FACILITY USES	MAX. NO. OF DWELLING UNITS ON A ZONING LOT CONTAINING BOTH COMMUNITY FACILITY & RESIDENTIAL USES SHALL EQUAL THE MAXIMUM RESIDENTIAL FLOOR AREA PERMITTED DETERMINED IN ACCORDANCE WITH SECTION 24-16 (SPECIAL PROVISIONS FOR ZONING LOTS CONTAINING BOTH COMM. FAC. & RES. USES) DIVIDED BY THE APPLICABLE FACTOR IN SECTION 23-20 (DENSITY REGULATIONS).		
YARD REGS.	ZR: 23-462	SIDE YARDS FOR ALL OTHER BUILDINGS CONTAINING RESIDENCES	R7A: IN THE DISTRICTS INDICATED, NO SIDE & YARDS ARE REQUIRED. HOWEVER, IF ANY R8A OPEN AREA EXTENDING ALONG A SIDE LOT LINE IS PROVIDED AT ANY LEVEL, IT SHALL MEASURE AT LEAST EIGHT FEET WIDE FOR THE ENTIRE LENGTH OF THE SIDE LOT LINE.	NO SIDE YARDS REQUIRED	NONE PROVIDED, OK
	ZR: 23-47	MIN. REQUIRED REAR YARDS	R8A: IN THE DISTRICTS INDICATED, A REAR YARD WITH A DEPTH OF NOT LESS THAN 30 FEET SHALL BE PROVIDED AT EVERY REAR LOT LINE ON ANY ZONING LOT EXCEPT AS OTHERWISE PROVIDED BY ZR23-54 (OTHER SPECIAL PROVISIONS FOR REAR YARDS)	RESIDENTIAL REAR YARD = MIN. 30'-0" REQUIRED.	30'-0" REAR YARD PROVIDED AT RESIDENTIAL FLOORS ON WESTERNMOST 3FT OF LOT 54, OK
	ZR: 23-541	WITHIN 100' OF CORNER	R7A: IN THE DISTRICTS INDICATED, NO REAR & YARD IS REQUIRED WITHIN 100' OF STREET R8A CORNER WITH ANGLE LESS THAN 135°	NO REAR YARD REQUIRED FOR EASTERN 75' OF LOT 54 & THE ENTIRETY OF LOT 59	NONE PROVIDED AS DESCRIBED, OK &
STREETWALL REGS.	ZR: 23-633	STREET WALL (a) (1) LOCATION REGS. IN CERTAIN DISTRICTS (R7A & R8A)	R7A: IN THE DISTRICT INDICATED, FOR ALL BUILDINGS, THE STREET WALL SHALL BE LOCATED NO CLOSER TO THE STREET LINE THAN THE CLOSEST STREET WALL OF AN EXISTING BUILDING TO SUCH STREET LINE, LOCATED ON THE SAME BLOCK, AND WITHIN 150 FEET OF SUCH BUILDING.	NORTH & SOUTH BUILDINGS ADJACENT TO LOT 54 ARE ON THE STREET LINE	PORTION OF THE PROPOSED BUILDING FRONTING SUFFOLK STREET (NARROW STREET) IS 3 FT FROM STREET LINE, OK &
		(a) (3)	R8A: IN THE DISTRICT INDICATED, FOR ALL BUILDINGS, THE FOLLOWING STREET WALL LOCATION PROVISIONS SHALL APPLY ALONG WIDE STREETS	(I) THE STREET WALL SHALL EXTEND ALONG THE ENTIRE STREET FRONTAGE OF A ZONING LOT	PORTION OF THE PROPOSED BUILDING FRONTING EAST HOUSTON STREET (WIDE STREET) IS ON THE STREET LINE, AND EXTENDS ACROSS THE ENTIRE STREET FRONTAGE, SET BACK FROM THE SIDE LO

	SECTION	TITLE OF SECTION	ZONING REGULATION - SUMMARY	ALLOWED AND / OR REQUIRED	PROVIDED
SETBACK REGS. AND	ZR: 23-662	(a) MAX. BLDG. & BASE HEIGHT FOR QUALITY HOUSING BUILDINGS	R7A MIN. & MAX. BASE, AND MAX. BULDING HT.	R7A: MIN. BASE HEIGHT = 40 FT MAX. BASE HEIGHT = 65 FT MAX. BLDG. HEIGHT = 85 FT	COMPLIES, SEE ZONING SECTIONS COMPLIES, SEE ZONING SECTIONS COMPLIES, SEE ZONING SECTIONS
MAXIMUM NUMBER OF PERMITTED OF FLOORS	ZR: 23-664	MODIFIED HEIGHT & SETBACK REGS. FOR CERTAIN INCLUSIONARY HOUSING BUILDINGS	R8A MAX. BASE & BLDG. HEIGHT, AND NUMBER OF PERMITTED STORIES FOR QUALITY HOUSING BUILDINGS IN MANDATORY INCLUSIONARY DESIG. DISTRICT	R7A: MAX. BASE HEIGHT = 105 FT MAX. BLDG. HEIGHT = 140 FT MAX. # OF FLRS. = 14	COMPLIES, SEE ZONING SECTIONS COMPLIES, SEE ZONING SECTIONS COMPLIES, SEE ZONING SECTIONS
WINDOW DISTANCE	ZR: 23-861	MINIMUM DISTANCE BETWEEN LEGALLY REQUIRED WINDOWS AND WALLS OR LOT LINES	R7A: IN THE DISTRICTS INDICATED, MIN. & DISTANCE BETWEEN LEGALLY REQUIRED R8A WINDOW AND ANY WALL, SIDE OR REAR LOT LINE SHALL BE 30'		COMPLIES - SEE ZONING SITE PLAN & SECTION, OK
	ZR: 23-863	MINIMUM DISTANCE BETWEEN LEGALLY REQUIRED WINDOWS AND ANY WALL IN AN INNER COURT	R7A: IN THE DISTRICTS INDICATED, MINIMUM & DISTANCE BETWEEN LEGALLY REQUIRED R8A WINDOW OPENING ON AN INNER COURT SHALL NOT BE NEARER THAN 30 FT TO THE OPPOSITE WALL, NOR LESS THAN HALF THE HEIGHT OF SUCH WALL ABOVE THE SILL LEVEL OF WINDOW.	HEIGHT OF SUFFOLK WING'S NORTH WALL OPPOSITE UNIT 2E BR WINDOW = 32'-0" REQUIRED SEPARATION = 30'-0"	COMPLIES - 30'-3" PROVIDED SEE ZONING SITE PLAN & SECTION, OK
NCLUSIONARY HOUSING REQUIREMENTS	ZR: 23-96	DISTRIBUTION (b) (1)	#AFFORDABLE HOUSING UNITS# SHALL BE DISTRIBUTED ON NOT LESS THAN 65% OF THE NUMBER OF FLOORS CONTAINING RESIDENTIAL UNITS.	65% x 12 FLOORS = 8 FLOORS OUT OF TOTAL RESIDENTIAL FLOORS 2-13, #AFFORDABLE HOUSING UNITS# ARE REQUIRED ON RESIDENTIAL FLOORS 2-9.	COMPLIED - SEE INCLUSIONARY HOUSING CHARTS ON Z-110
		(b) (2)	#AFFORDABLE HOUSING UNITS# SHALL NOT COMPRISE MORE THAN ONE-THIRD OF THE TOTAL NUMBER OF D.U. ON ANY #STORY#		COMPLIED - SEE INCLUSIONARY HOUSING CHARTS ON Z-110 ❤
		AFFORDABLE D.U. MIX (c)	THE AFFORDABLE D.U.S SHALL CONTAIN A BEDROOM MIX AT LEAST PROPORTIONAL TO THE BEDROOM MIX OF THE MARKET RATE D.U.S.		COMPLIED - SEE INCLUSIONARY HOUSING CHARTS ON Z-110 ✓
		AFFORDABLE D.U. SIZE (d)	MINIMUM FLOOR AREA WITHIN THE PERIMETER WALLS OF THE AFFORDABLE D.U. AS FOLLOWS: STUDIO 400 SF 1-BR 575 SF 2-BR 775 SF		COMPLIED - SEE INCLUSIONARY HOUSING CHARTS ON Z-110 ✓
VEHICULAR PARKING	ZR: 12-10	DEFINITIONS	THE "MANHATTAN CORE" IS THE AREA WITHIN MANHATTAN COMMUNITY DISTRICTS 1, 2, 3, 4, 5, 6, 7 AND 8.		
	ZR: 13-10	PERMITTED OFF-STREET PARKING IN THE "MANHATTAN CORE"	NO PARKING SHALL BE REQUIRED WITHIN THE "MANHATTAN CORE".	NO VEHICULAR OFF-STREET PARKING REQUIRED	2 SPACES PROVIDED, OK
BICYCLE PARKING	ZR: 25-811	ENCLOSED BICYCLE PARKING SPACES	WHERE A BUILDING OR ZONING LOT CONTAINS TWO OR MORE USES HAVING DIFFERENT BICYCLE PARKING REQUIREMENTS, THE REQUIREMENTS FOR EACH TYPE OF USE SHALL APPLY TO THE EXTENT OF THAT USE. THE REQUIRED NUMBER OF SPACES FOR THE USE TO WHICH SUCH FACILITY IS ACCESSORY SHALL BE: USE GROUP 2: 1 PER 2 D.U.	88 D.U. / 2 = 44 BIKES	
	ZR: 25-83	RESTRICTIONS ON OPERATION, SIZE AND LOCATION OF ENCLOSED BICYCLE PARKING SPACES	USE GROUP 3 (UNLISTED): 1 PER 10,000 S.F. ENCLOSED ACCESSORY BICYCLE PARKING SHALL BE SURROUNDED ON ALL SIDES BY A SOLID ENCLOSURE. EACH BICYCLE SPACE SHALL ADJOIN A RACK OR SIMILAR SYSTEM FOR SECURING THE BICYCLE. SPACES SHALL BE LOCATED IN AN AREA SECURED BY A LOCK OR SIMILAR MEANS, OR ADJOIN A SECURELY-ANCHORED RACK TO WHICH THE BICYCLE FRAME AND AT LEAST ONE WHEEL CAN BE LOCKED.	4,510 S.F. = 1 BIKE	
QUALITY	ZR: 28-21	MINIMUM SIZE OF DWELLING	15 S.F. OF AREA SHALL BE PROVIDED FOR EACH REQUIRED BICYCLE SPACE. DWELLING UNITS SHALL HAVE A MINIMUM FLOOR	[45 BIKES X 15 S.F.] = 675 S.F. REQUIRED	PROVIDED = 675 S.F., OK SMALLEST UNIT = 404 SF NET, OK
HOUSING REQ'TS	ZR: 28-22	UNITS WINDOWS	AREA OF 400 S.F. ALL WINDOWS IN THE RESIDENTIAL PORTION OF THE DEVELOPMENT SHALL BE DOUBLE GLAZED.		(STUDIO "G") WINDOWS ARE DOUBLE GLAZED OITC RATING 37
	ZR: 28-23	REFUSE STORAGE & DISPOSAL	REFUSE STORAGE SHALL BE ENTIRELY WITHIN AN ENCLOSED AREA IN THE BUILDING & APPROPRIATE LOCATIONS DELINEATED FOR THIS PURPOSE. A REFUSE ROOM OF 12 S.F. MIN. w. NO DIMENSION LESS THAN 3 FT SHALL BE PROVIDED ON EACH STORY CONTAINING DWELLING UNITS. 12 S.F. OF SUCH FLOOR AREA IS EXEMPT FROM INCLUSION IN F.A.R.		REFUSE COMPACTOR ROOM PROVIDED AT CELLAR LEVEL, OK ALL RESIDENTIAL FLOORS HAVE A REFUSE ROOM WITH A DIRECT INTAKE TO THE REFUSE CHUTE, OK FLOOR AREA HAS BEEN REMOVED, SEE ZONING DIAGRAMS ON Z-110, OK
	ZR: 28-24	LAUNDRY FACILITIES	AT LEAST ONE WASHING MACHINE PER 20 D.U. & AT LEAST ONE DRYER PER 40 D.U.		ALL D.U. HAVE WASHER/DRYER. IN ADDITION, COMMON LAUNDRY ROOM IN CELLAR IS PROVIDED WITH TWO ADA-COMPLIANT WASHERS & DRYERS.
	ZR: 28-25	DAYLIGHT IN CORRIDORS	50% OF CORRIDOR FLOOR AREA IS EXEMPT FROM INCLUSION IN F.A.R. PROVIDED THAT A CLEAR GLAZED WINDOW OF 20 S.F. MIN. IS ARRANGED IN THE CORRIDOR SUCH THAT IT BE DIRECTLY VISIBLE FROM THE VERTICAL CIRCULATION CORE; AND IS LOCATED AT LEAST 20 FT FROM A WALL, A SIDE OR REAR LOT LINE AS MEASURED HORIZONTALLY PERPENDICULAR TO THE WINDOW OPENING.		GLASS LINK BRIDGE CONNECTING THE PROJECT'S TWO WINGS AT THE CORE PROVIDES SUCH LIGHT.
	ZR: 28-31	REQUIRED RECREATION SPACE	ALL DEVELOPMENTS WITH 9 OR MORE DWELLING UNITS SHALL PROVIDE THE MINIMUM AMOUNT OF RECREATION SPACE, AS A PERCENTAGE OF RESIDENTIAL F.A.R., SET FORTH IN THIS SECTION. FLOOR AREA OF INDOOR RECREATION SPACE PROVIDED IS EXEMPT FROM INCLUSION IN F.A.R. R7A: REC. SPACE REQ'D: 3.3 % R8A: REC. SPACE REQ'D: 2.8 %		SEE ZR 77-40 BELOW
	ZR: 28-31	DENSITY PER CORRIDOR	IF THE NUMBER OF UNITS PER FLOOR DOES NOT EXCEED THE NUMBER, PER ZONING DISTRICT SHOWN BELOW, 50% OF THE CORRIDOR FLOOR AREA IS EXEMPT FROM INCLUSION IN F.A.R.	R7A: 11 UNITS / FLOOR R8A: 10 UNITS / FLOOR	MAX. NO. OF D.U. / CORRIDOR = 9, OK
	ZR: 77-40	SUPPLEMENTAL REGULATIONS (FOR ZONING LOTS DIVIDED BY DISTRICT BOUNDARIES)	FOR BUILDINGS DEVELOPED ON ZONING LOTS DIVIDED A DISTRICT BOUNDARY, THE FOLLOWING SECTIONS OF ARTICLE II, CHAPTER 8, SHALL APPLY TO THE ENTIRE BUILDING. WHERE EACH DISTRICT HAS A DIFFERENT RECREATION SPACE REQUIREMENT, AND DENSITY OF DWELLING UNITS PER CORRIDOR, ONE STANDARD FOR THE BUILDING IS DERIVED BY MULTIPLYING EACH STANDARD BY THE % OF THE ZONING LOT TO WHICH IT APPLIES. THE SUM OF THE PRODUCTS THUS OBTAINED IS THE ADJUSTED STANDARD APPLICABLE TO THE BUILDING. R7A: REC. SPACE REQ'D: 3.3 % R8A: REC. SPACE REQ'D: 2.8 % R7A: D.U. DENSITY / CORR. 10	PROPORTIONATE R7A REC. SPACE REQ'D: [(2,603 / 10,843) x 3.3 %] = 0.792 % PROPORTIONATE R8A REC. SPACE REQ'D: [(8,240 / 10,843) x 2.8 %] = 2.128 % ADJUSTED REC. SPACE REQ'T = 2.128 + 0.792 = 2.920 % TOTAL REC. SPACE REQUIRED = [(69,470 - 4,510) x 0.0292] = 1,905 S.F. PROPORTIONATE R7A MAX. D.U. / CORR.: [(2,603 / 10,843) X 10] = 2.40 D.U. PROPORTIONATE R8A MAX. D.U. / CORR.: [(8,240 / 10,843) X 11] = 8.36 D.O.	INDOOR REC. SPACE PROVIDED = 1,465 SF (1ST FLR) + 490 SF (14TH FLR) = 1,955 S.F., OK REC. SPACE DEDUCTION FROM F.A.R. = 1,905 S.F.
				= 8.36 D.O. ADJUSTED MAX. D.U. / CORR. = 2.40 + 8.36 = 10.76 D.U. / CORRIDOR	NO. OF D.U. / CORRIDOR PROV. = 9, OK ❤
	ZR: 28-33	PLANTING AREAS	AREA OF ZONING LOT BETWEEN STREET LINE & STREET WALL OF THE BUILDING SHALL BE PLANTED AT GROUND LEVEL, OR IN RAISED PLANTING BEDS THAT ARE PERMANENTLY AFFIXED TO THE GROUND, PER ZR 23-892		SEE 1ST FLR. PLAN (A-110) PROVIDED, OK ≪

FLOOR	GROSS CONSTRUCTED FLOOR AREA PER FLOOR	# OF		/ FLOOR G DISTRICT	TOTAL RESID	DENTIAL G.F.A		COMMUNITY LITY G.F.A.	MECHANICA	L DEDUCTION	Q.H. DEI	DUCTION		POSED Z.F.A. G DISTRICT	TOTAL PROP. Z.F.A.
		FLR	R7A	R8A	R7A	R8A	R7A	R8A	R7A	R8A	R7A	R8A	R7A	R8A	
CELLAR	10,792.0 SF	1	0 SF	0 SF	0 SF	0 SF	0 SF	0 SF	0 SF	0 SF	0 SF	0 SF	0 SF	0 SF	0 SF
1ST - C. F.	8,637.7 SF	4	0 SF 4510.1 SF	1,296.3 SF	2,831.3 SF	0 SF	4,510.1 SF	66 F 8F	22.5.05			360.5 SF 6,801.6 SF	7.460.4.65		
1ST - RES.	- 0,037.7 35	1	1,296.3 SF	2,831.3 SF	1,290.3 3F	2,031.3 3F	0 SF	4,510.1 5F	66.5 SF	0.0 SF	869.3 SF	539.8 SF	360.5 SF	0,001.0 3F	7,162.1 SF
2ND - RES.	7,197.5 SF	1	1,646.0 SF	5,552 SF	1,646.0 SF	5,551.6 SF	0 SF	0 SF	66.3 SF	257.0 SF	74.6 SF	706.3 SF	1,505.0 SF	4,588.3 SF	6,093.3 SF
3RD-5TH FLR	7,624.9 SF	3	1,646.0 SF	5,979.0 SF	4,937.9 SF	17,936.9 SF	0 SF	0 SF	200.7 SF	832.8 SF	223.9 SF	2,118.8 SF	4,513.3 SF	14,985.3 SF	19,498.6 SF
6TH-7TH FLR	7,659.1 SF	2	1,664.9 SF	5,994.2 SF	3,329.8 SF	11,988.4 SF	0 SF	0 SF	133.8 SF	555.2 SF	149.3 SF	1,412.6 SF	3,046.7 SF	10,020.7 SF	13,067.4 SF
8TH FLR	6,564.5 SF	1	912.9 SF	5,651.5 SF	912.9 SF	5,651.5 SF	0 SF	0 SF	33.1 SF	247.4 SF	0 SF	611.1 SF	879.9 SF	4,793.1 SF	5,673.0 SF
9TH FLR	4,614.0 SF	1	0 SF	4,614.0 SF	0 SF	4,614.0 SF	0 SF	0 SF	0 SF	202.9 SF	0 SF	421.1 SF	0 SF	3,990.0 SF	3,990.0 SF
10TH FLR	4,257.8 SF	1	0 SF	4,257.8 SF	0 SF	4,257.8 SF	0 SF	0 SF	0 SF	220.0 SF	0 SF	421.1 SF	0 SF	3,616.7 SF	3,616.7 SF
11TH-13TH FLR	3,869.7 SF	3	0 SF	3,869.7 SF	0 SF	11,609.1 SF	0 SF	0 SF	0 SF	610.2 SF	0 SF	1,263.3 SF	0 SF	9,735.6 SF	9,735.6 SF
ROOF	1,232.2 SF	1	0 SF	1,232.2 SF	0 SF	1,232.2 SF	0 SF	0 SF	0 SF	48.3 SF	0 SF	494.3 SF	0 SF	689.7 SF	689.7 SF
TOTALS	93,097.7 S.F.	15	7,166.0 SF	44,491.4 SF	12,122.9 SF	65,672.8 SF	0 SF	4,510.1 SF	500.4 S.F.	2,973.7 S.F.	1,317.1 S.F.	7,988.2 S.F.	10,305.4 S.F.	59,221.0 S.F.	69,526.3 S.F.

3 FEMA FLOOD MAPS
SCALE: N.T.S.

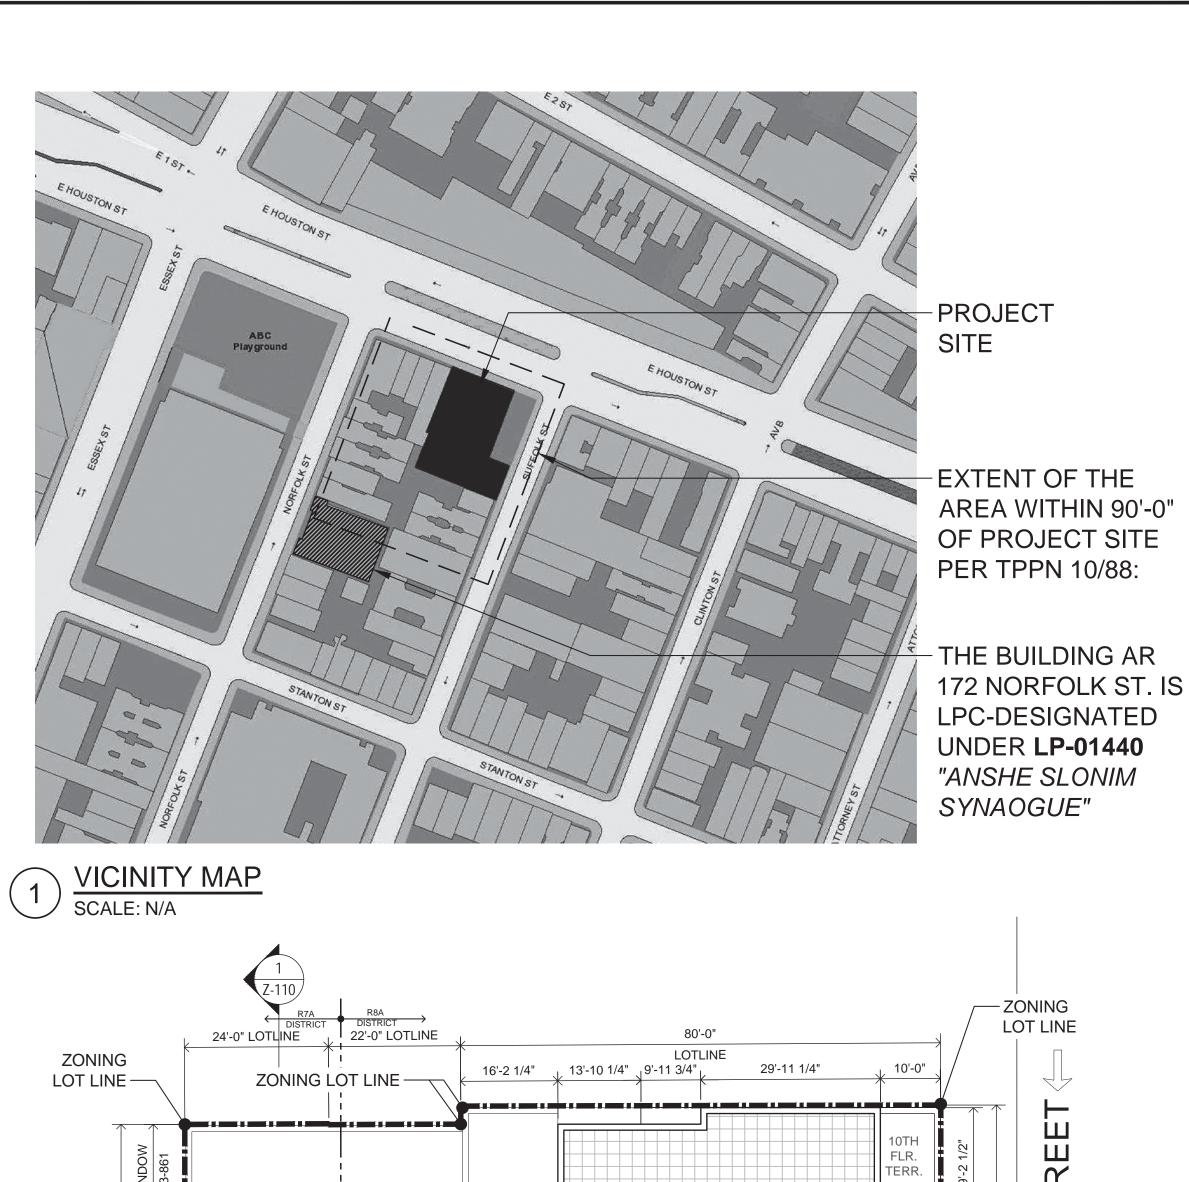

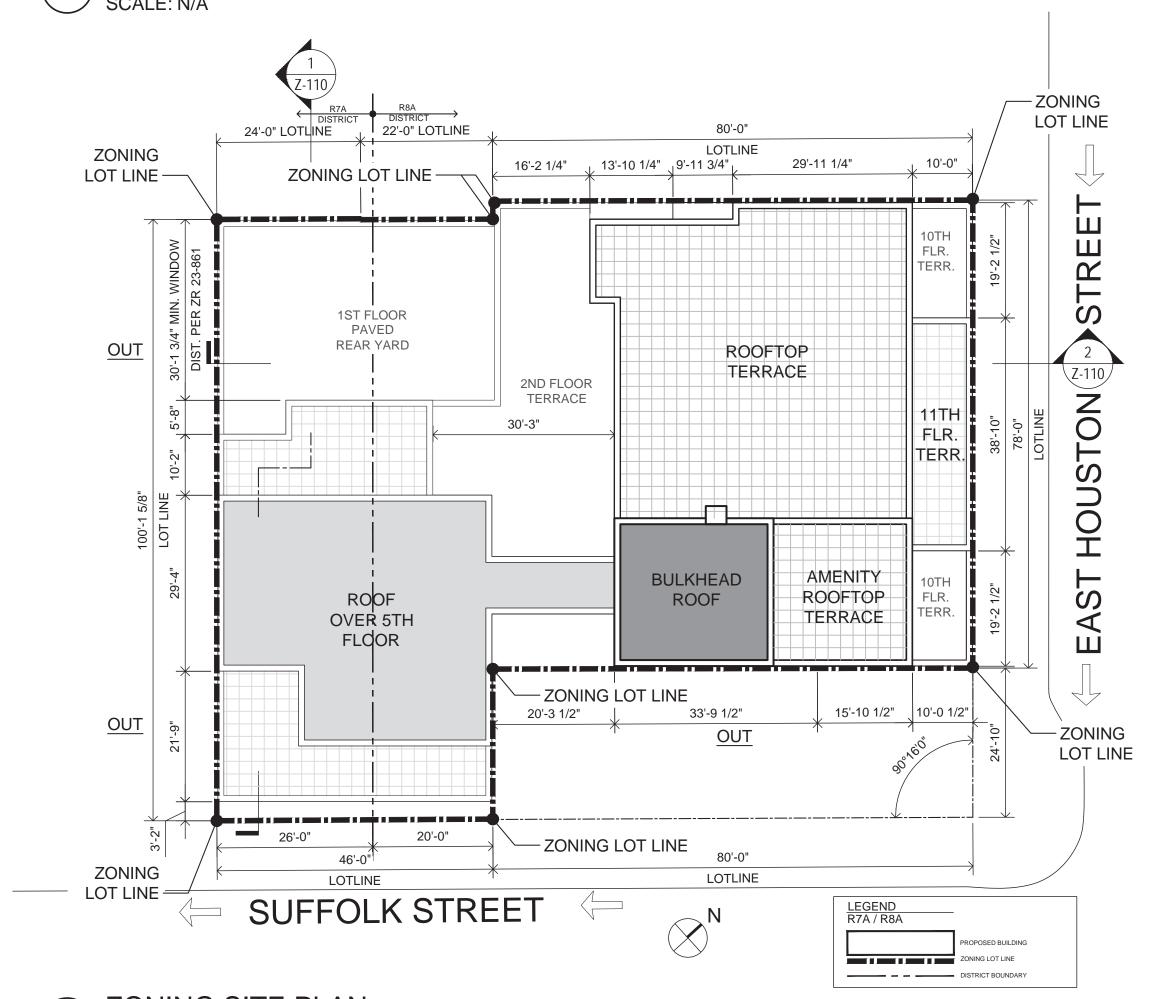

 $2 \frac{\text{ZONING SITE PLAN}}{\text{SCALE: 1/16"} = 1'-0"}$



SPECIAL FLOOD HAZARD AREAS SUBJECT TO INUNDATION BY THE 1% ANNUAL CHANCE FLOOD The 1% annual flood (100-year flood), also known as the base flood, is the flood that has a 1% chance of being equaled or exceeded in any given year. The Special Flood Hazard Area is the area subject to flooding by the 1% annual chance flood. Areas of Special Flood Hazard include Zones A, AE, AH, AO, AR, A99, V, and VE. The Base Flood Elevation is the water-surface elevation of the 1% annual chance flood.

ZONE AE Base Flood Elevations determined. ZONE AH Flood depths of 1 to 3 feet (usually areas of ponding); Base Flood Elevations determined. ZONE AO Flood depths of 1 to 3 feet (usually sheet flow on sloping terrain); average depths determined. For areas of alluvial fan flooding, velocities also determined. Special Flood Hazard Area formerly protected from the 1% annual chance flood by a flood control system that was subsequently decertified. Zone AR indicates that the former flood control system is being restored to provide protection from the 1% annual chance or greater flood. ZONE A99 Area to be protected from 1% annual chance flood by a Federal flood protection system under construction; no Base Flood Elevations determined. Coastal flood zone with velocity hazard (wave action); no Base Flood Elevations determined.


FLOODWAY AREAS IN ZONE AE The floodway is the channel of a stream plus any adjacent floodplain areas that must be kept free of encroachment so that the 1% annual chance flood can be carried without substantial increases in flood heights.

Areas of 0.2% annual chance flood; areas of 1% annual chance flood with average depths of less than 1 foot or with drainage areas less than 1 square mile; and areas protected by levees from 1% annual chance flood. Areas determined to be outside the 0.2% annual chance floodplain. Areas in which flood hazards are undetermined, but possible. COASTAL BARRIER RESOURCES SYSTEM (CBRS) AREAS OTHERWISE PROTECTED AREAS (OPAs) CBRS areas and OPAs are normally located within or adjacent to Special Flood Hazard Areas.

Floodway boundary - - Zone D boundary CBRS and OPA boundary Boundary dividing Special Flood Hazard Area Zones and boundary dividing Special Flood Hazard Areas of different Base Flood Elevations, flood depths or flood velocities. Sase Flood Elevation line and value; elevation in feet* Base Flood Elevation value where uniform within zone; elevation in feet $\!\!\!\!\!^*$ (EL 987)

* Referenced to the National Geodetic Vertical Datum of 1929 Cross section line 23-----23 87°07'45", 32°22'30" Geographic coordinates referenced to the North American Datum of 1983 (NAD 83), Western Hemisphere 1000-meter Universal Transverse Mercator grid values, zone 5000-foot grid ticks: New York State Plane coordinate system, Long Island zone (FIPSZONE 3104), Lambert Conformal Conic projection Bench mark (see explanation in Notes to Users section of this FIRM panel) River Mile

MAP REPOSITORY Refer to listing of Map Repositories on Map Index INITIAL NFIP MAP DATE June 28, 1974 FLOOD HAZARD BOUNDARY MAP REVISIONS June 11, 1976 FLOOD INSURANCE RATE MAP EFFECTIVE November 16, 1983 FLOOD INSURANCE RATE MAP REVISIONS September 5, 2007 - to update map format, to change Special Flood Hazard Areas, and to reflect updated topographic information

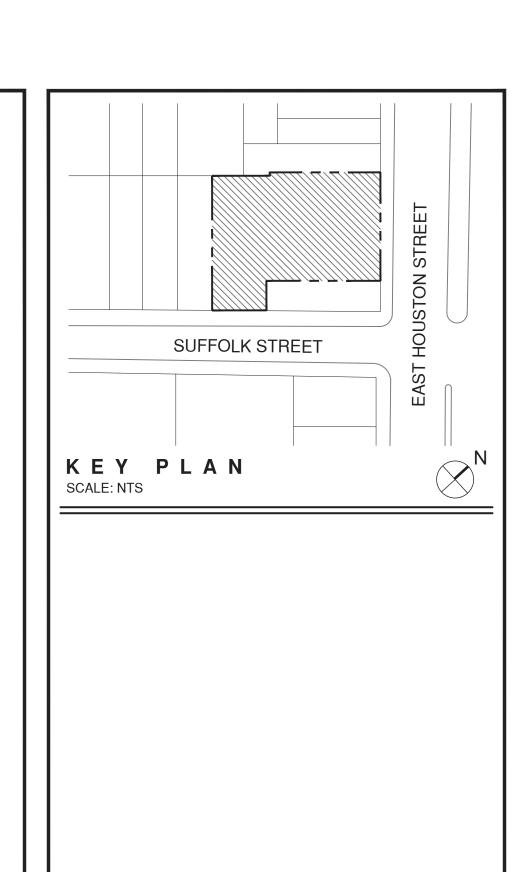

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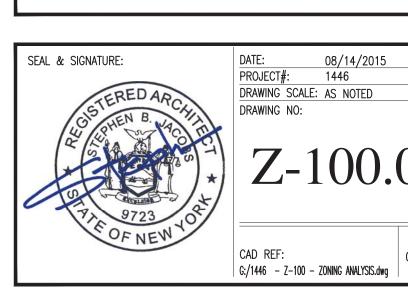
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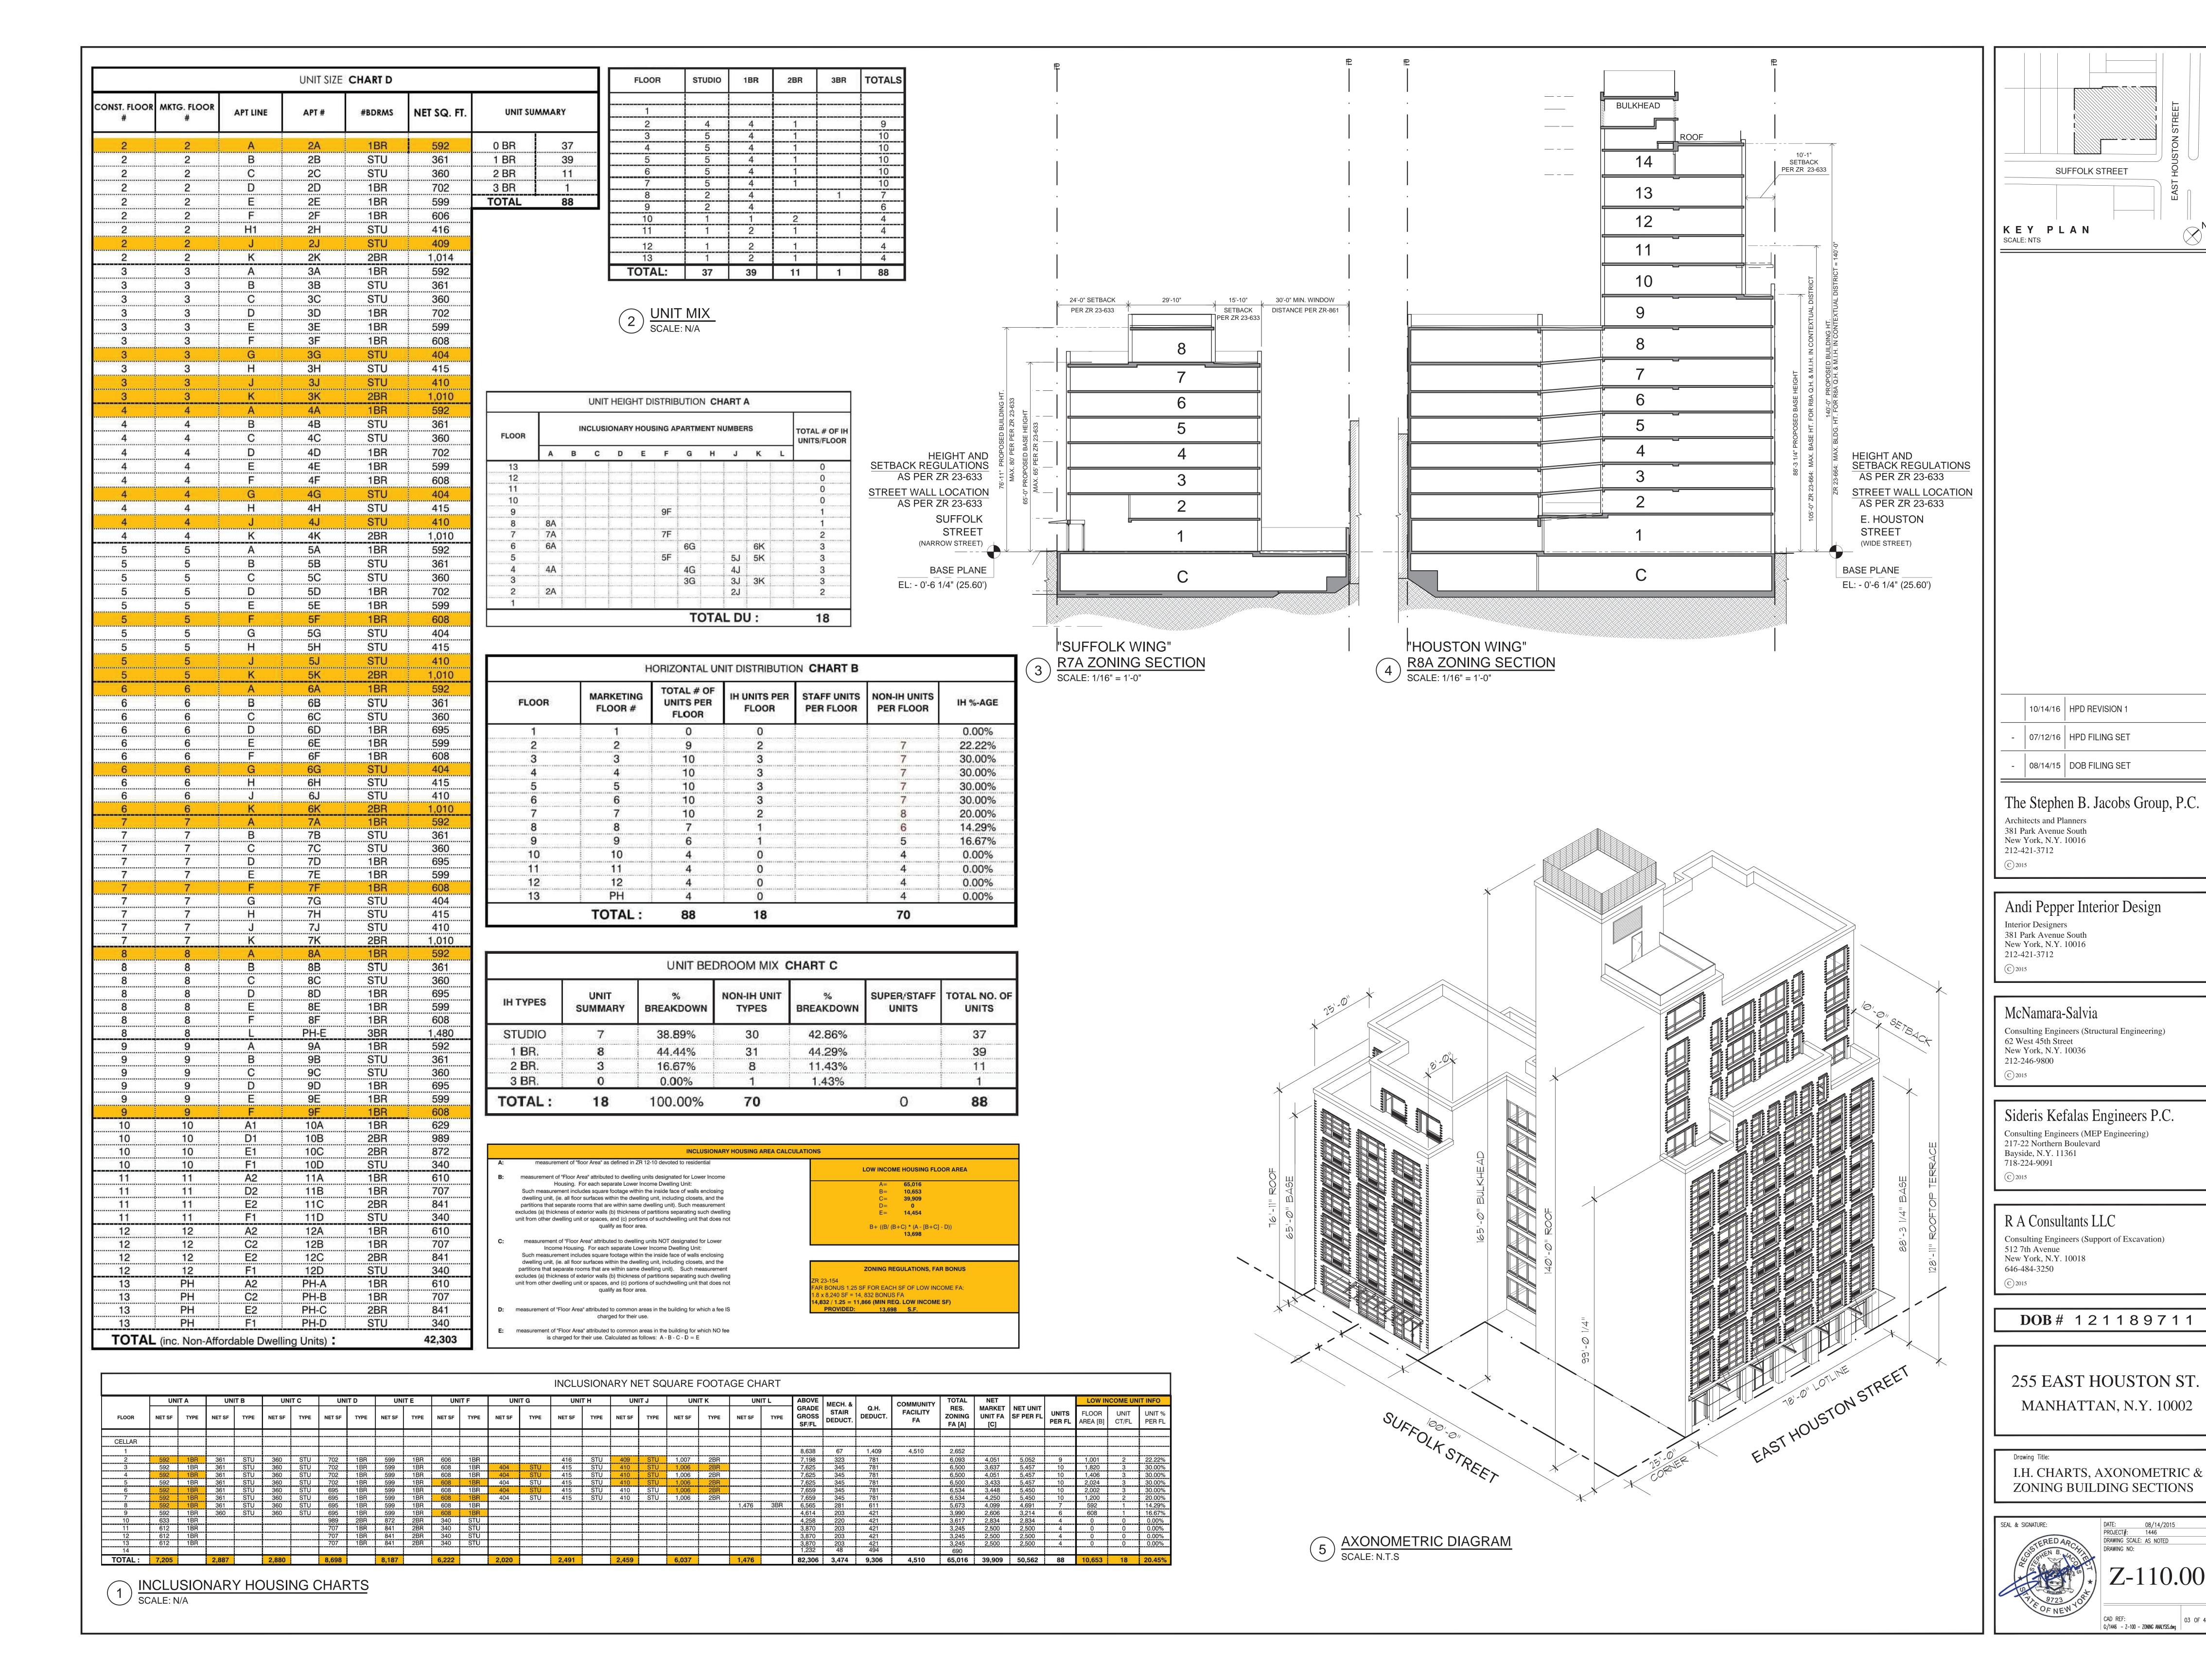
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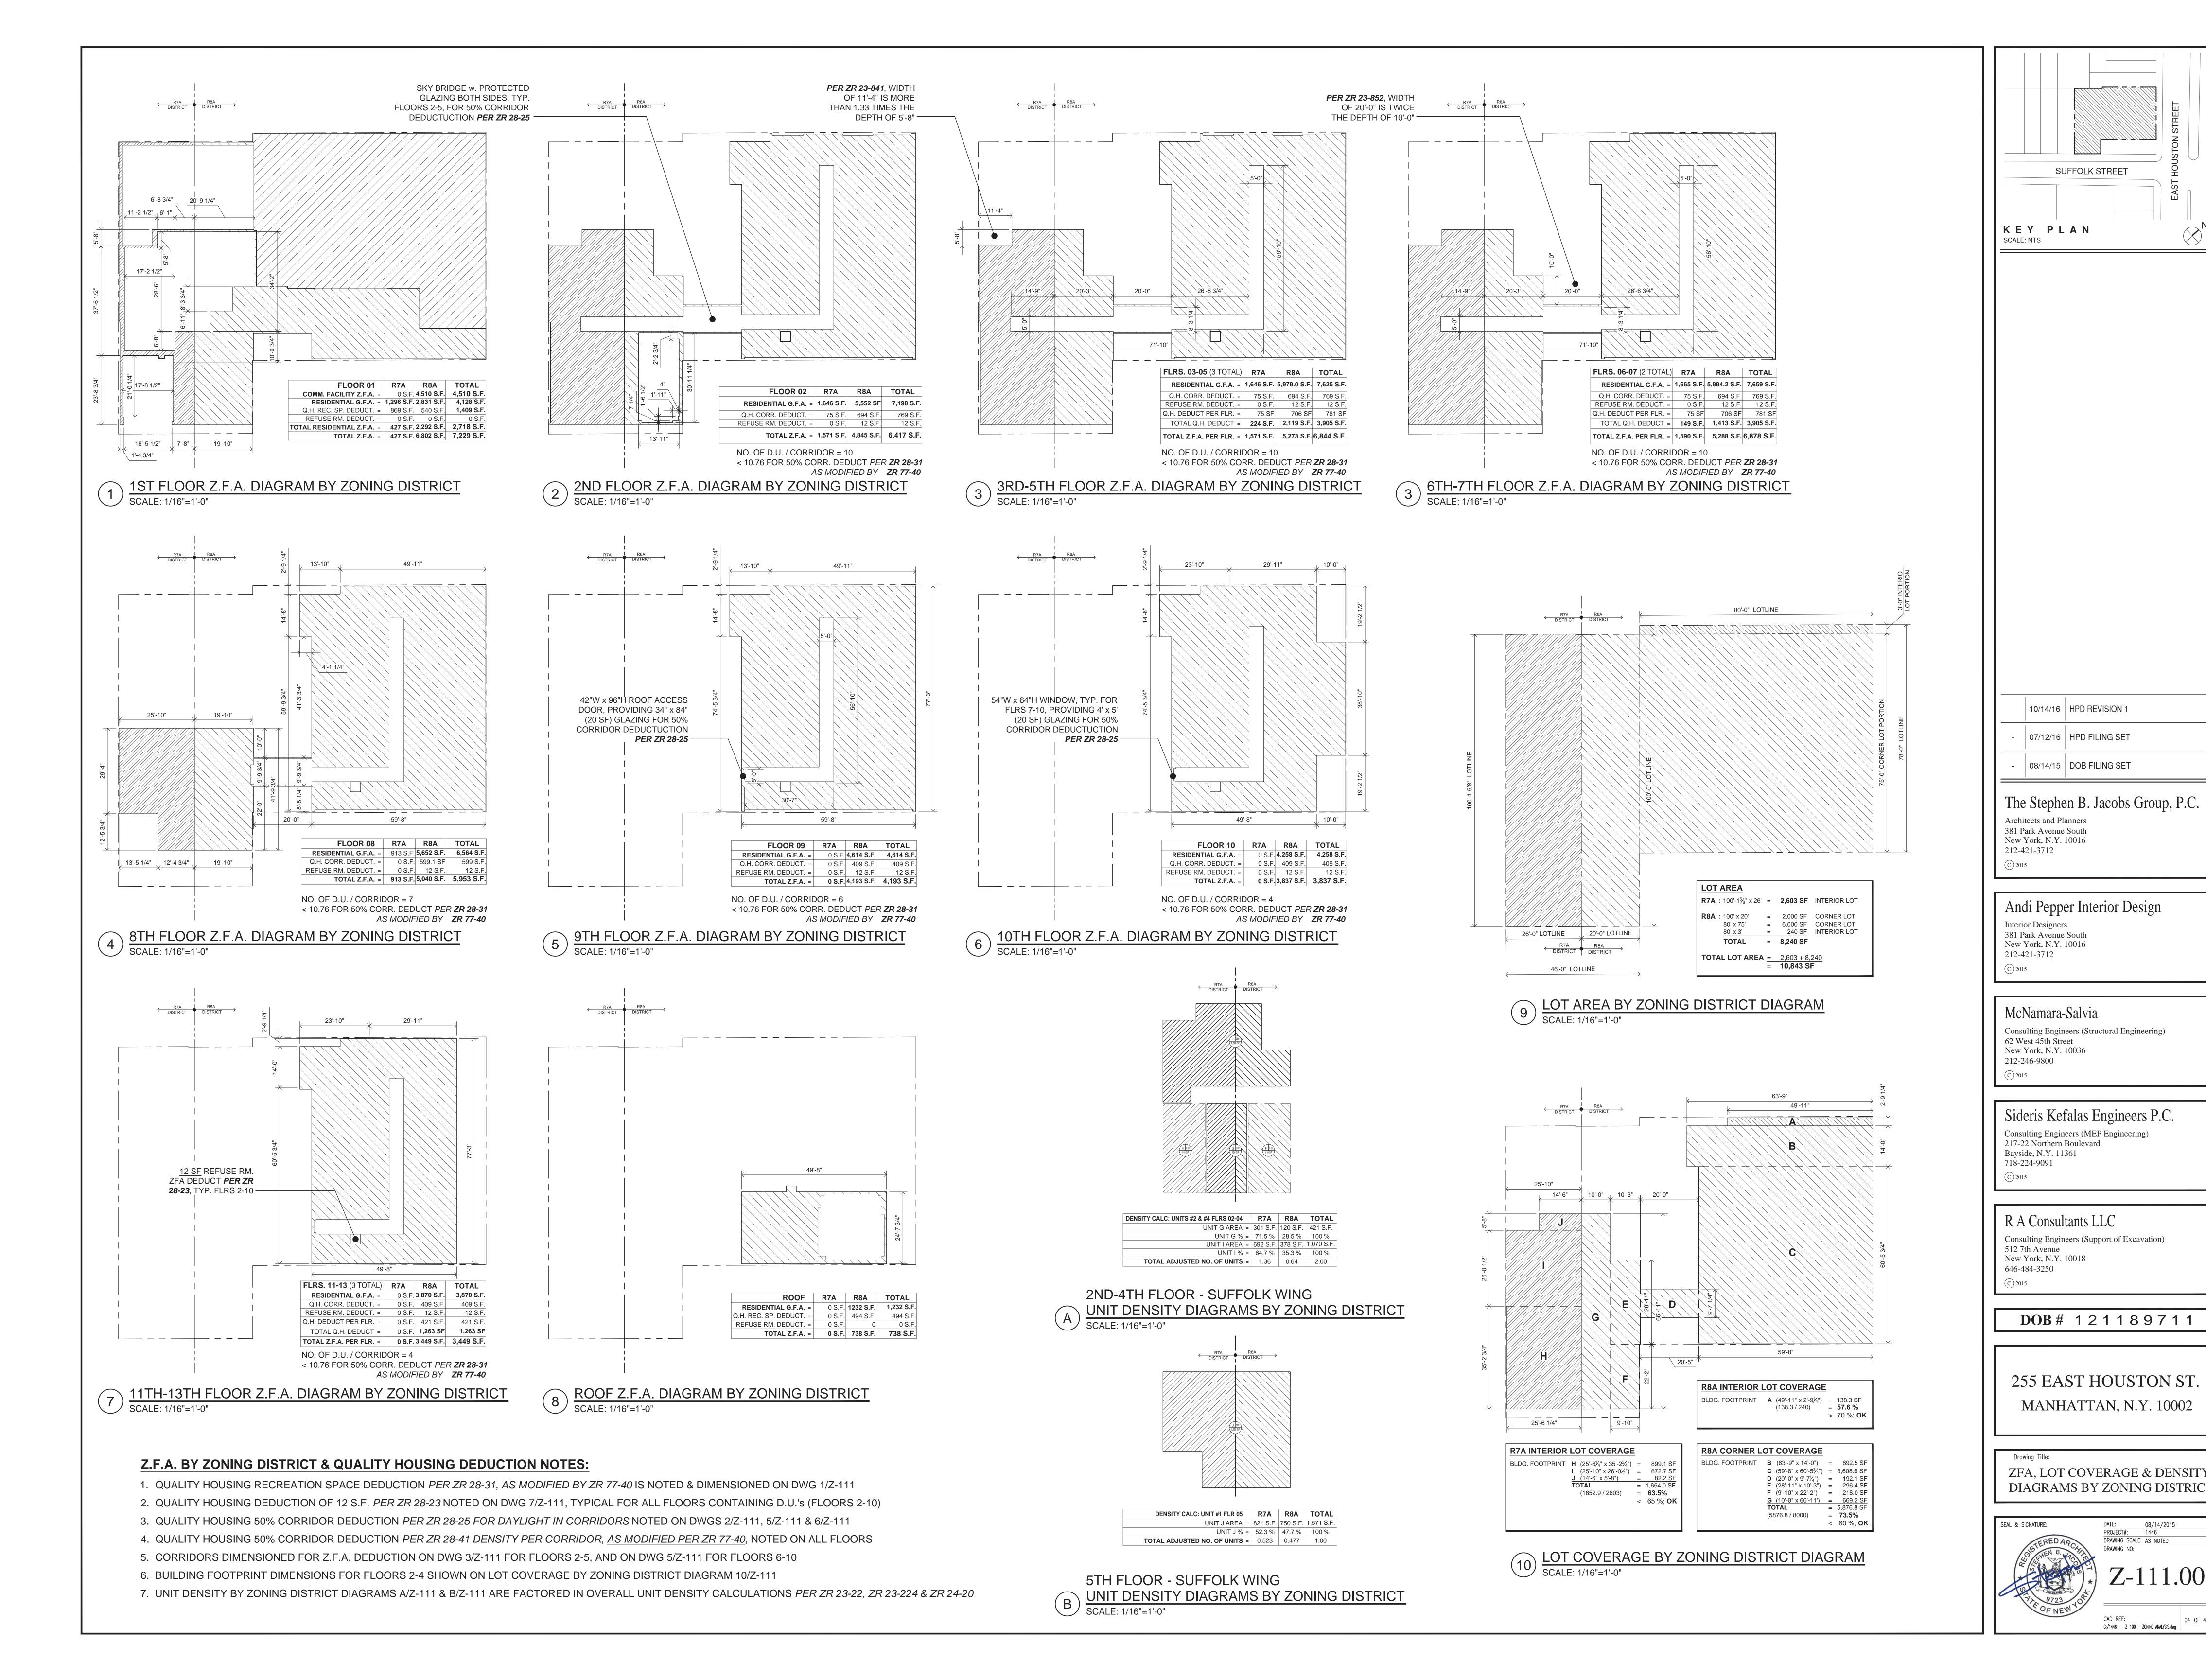
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VICINITY & FEMA MAPS



4 ZONING FLOOR AREA DISTRUBTION CHART SCALE: N/A






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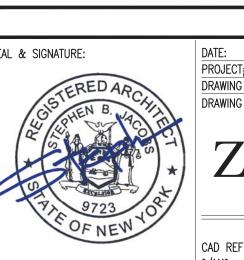
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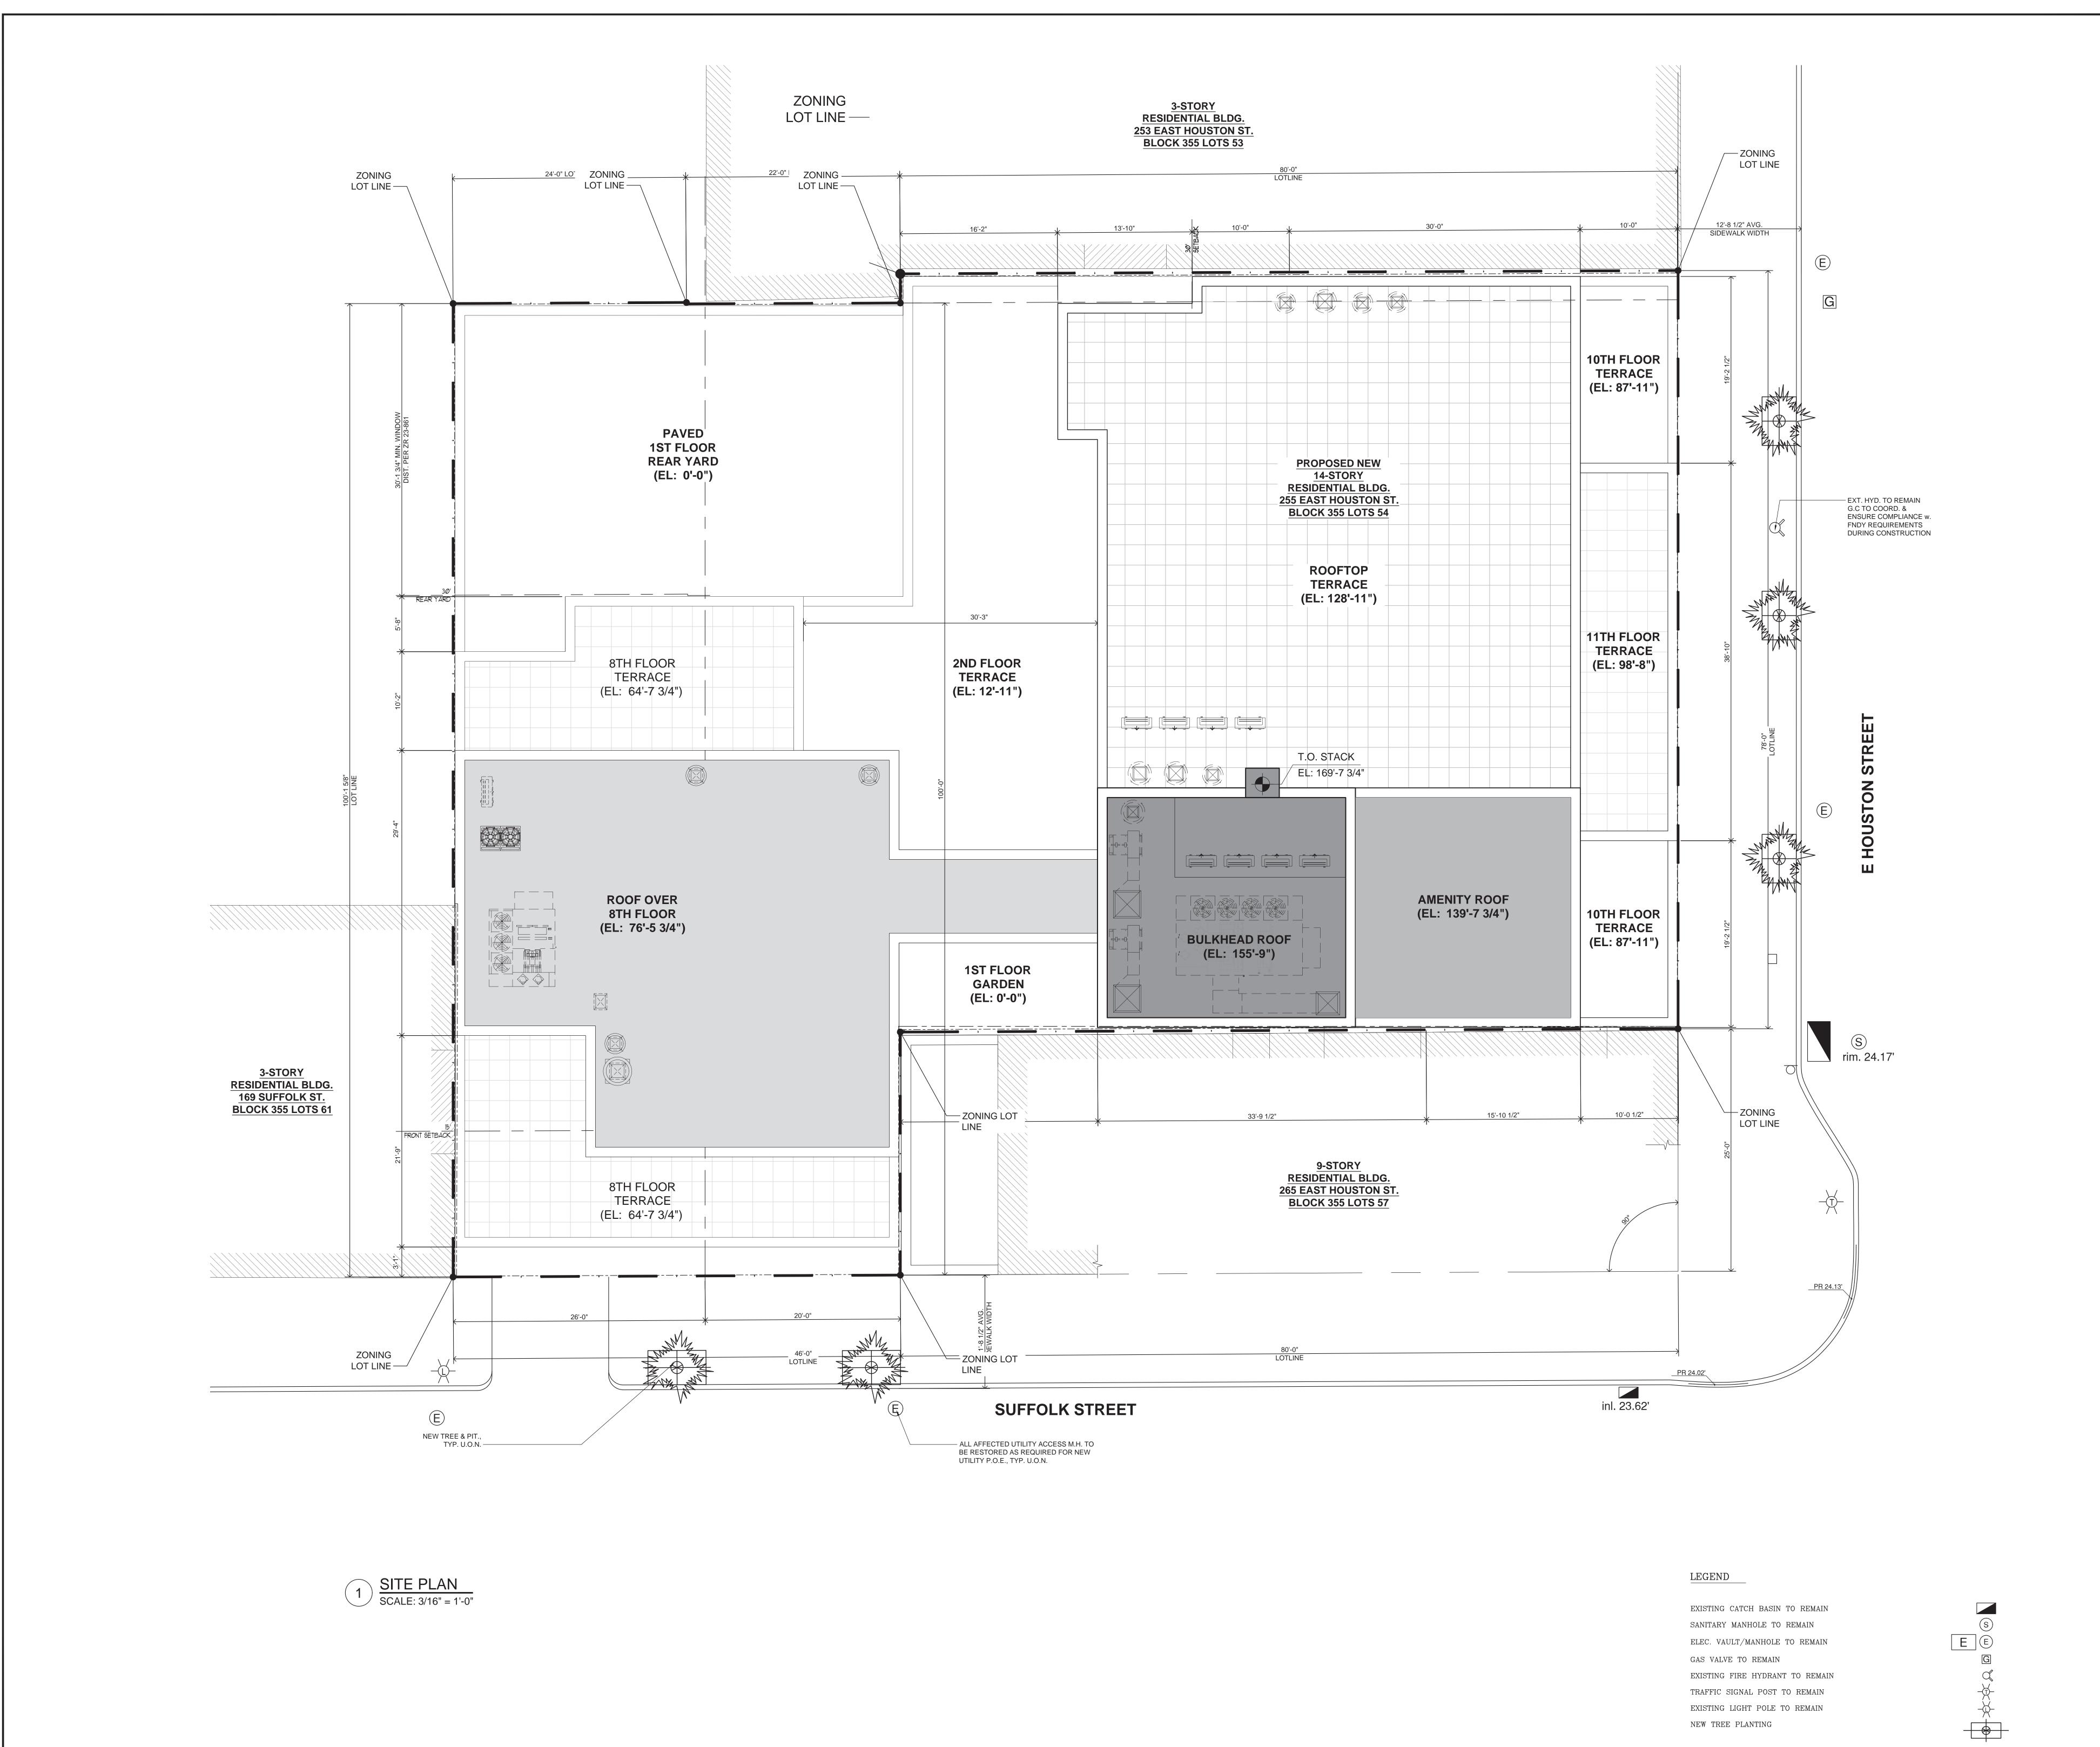
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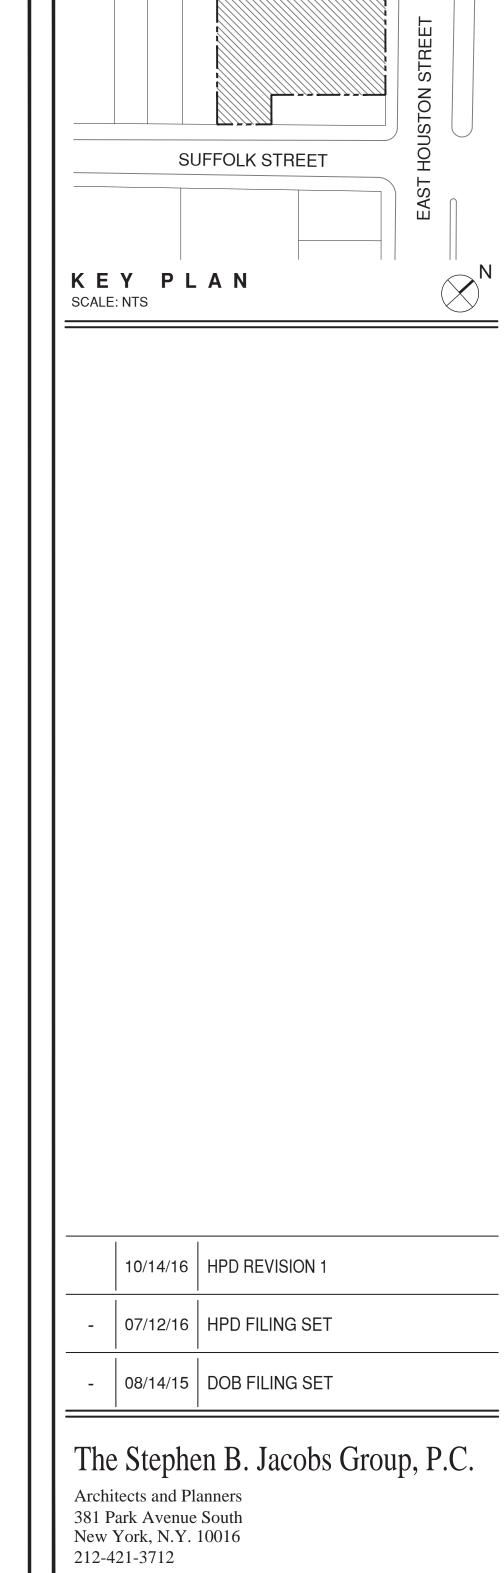
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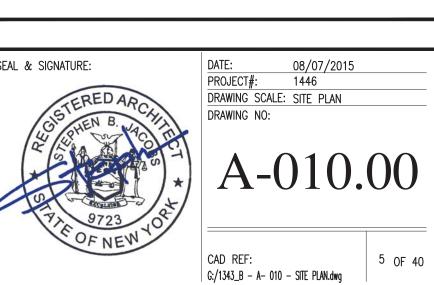
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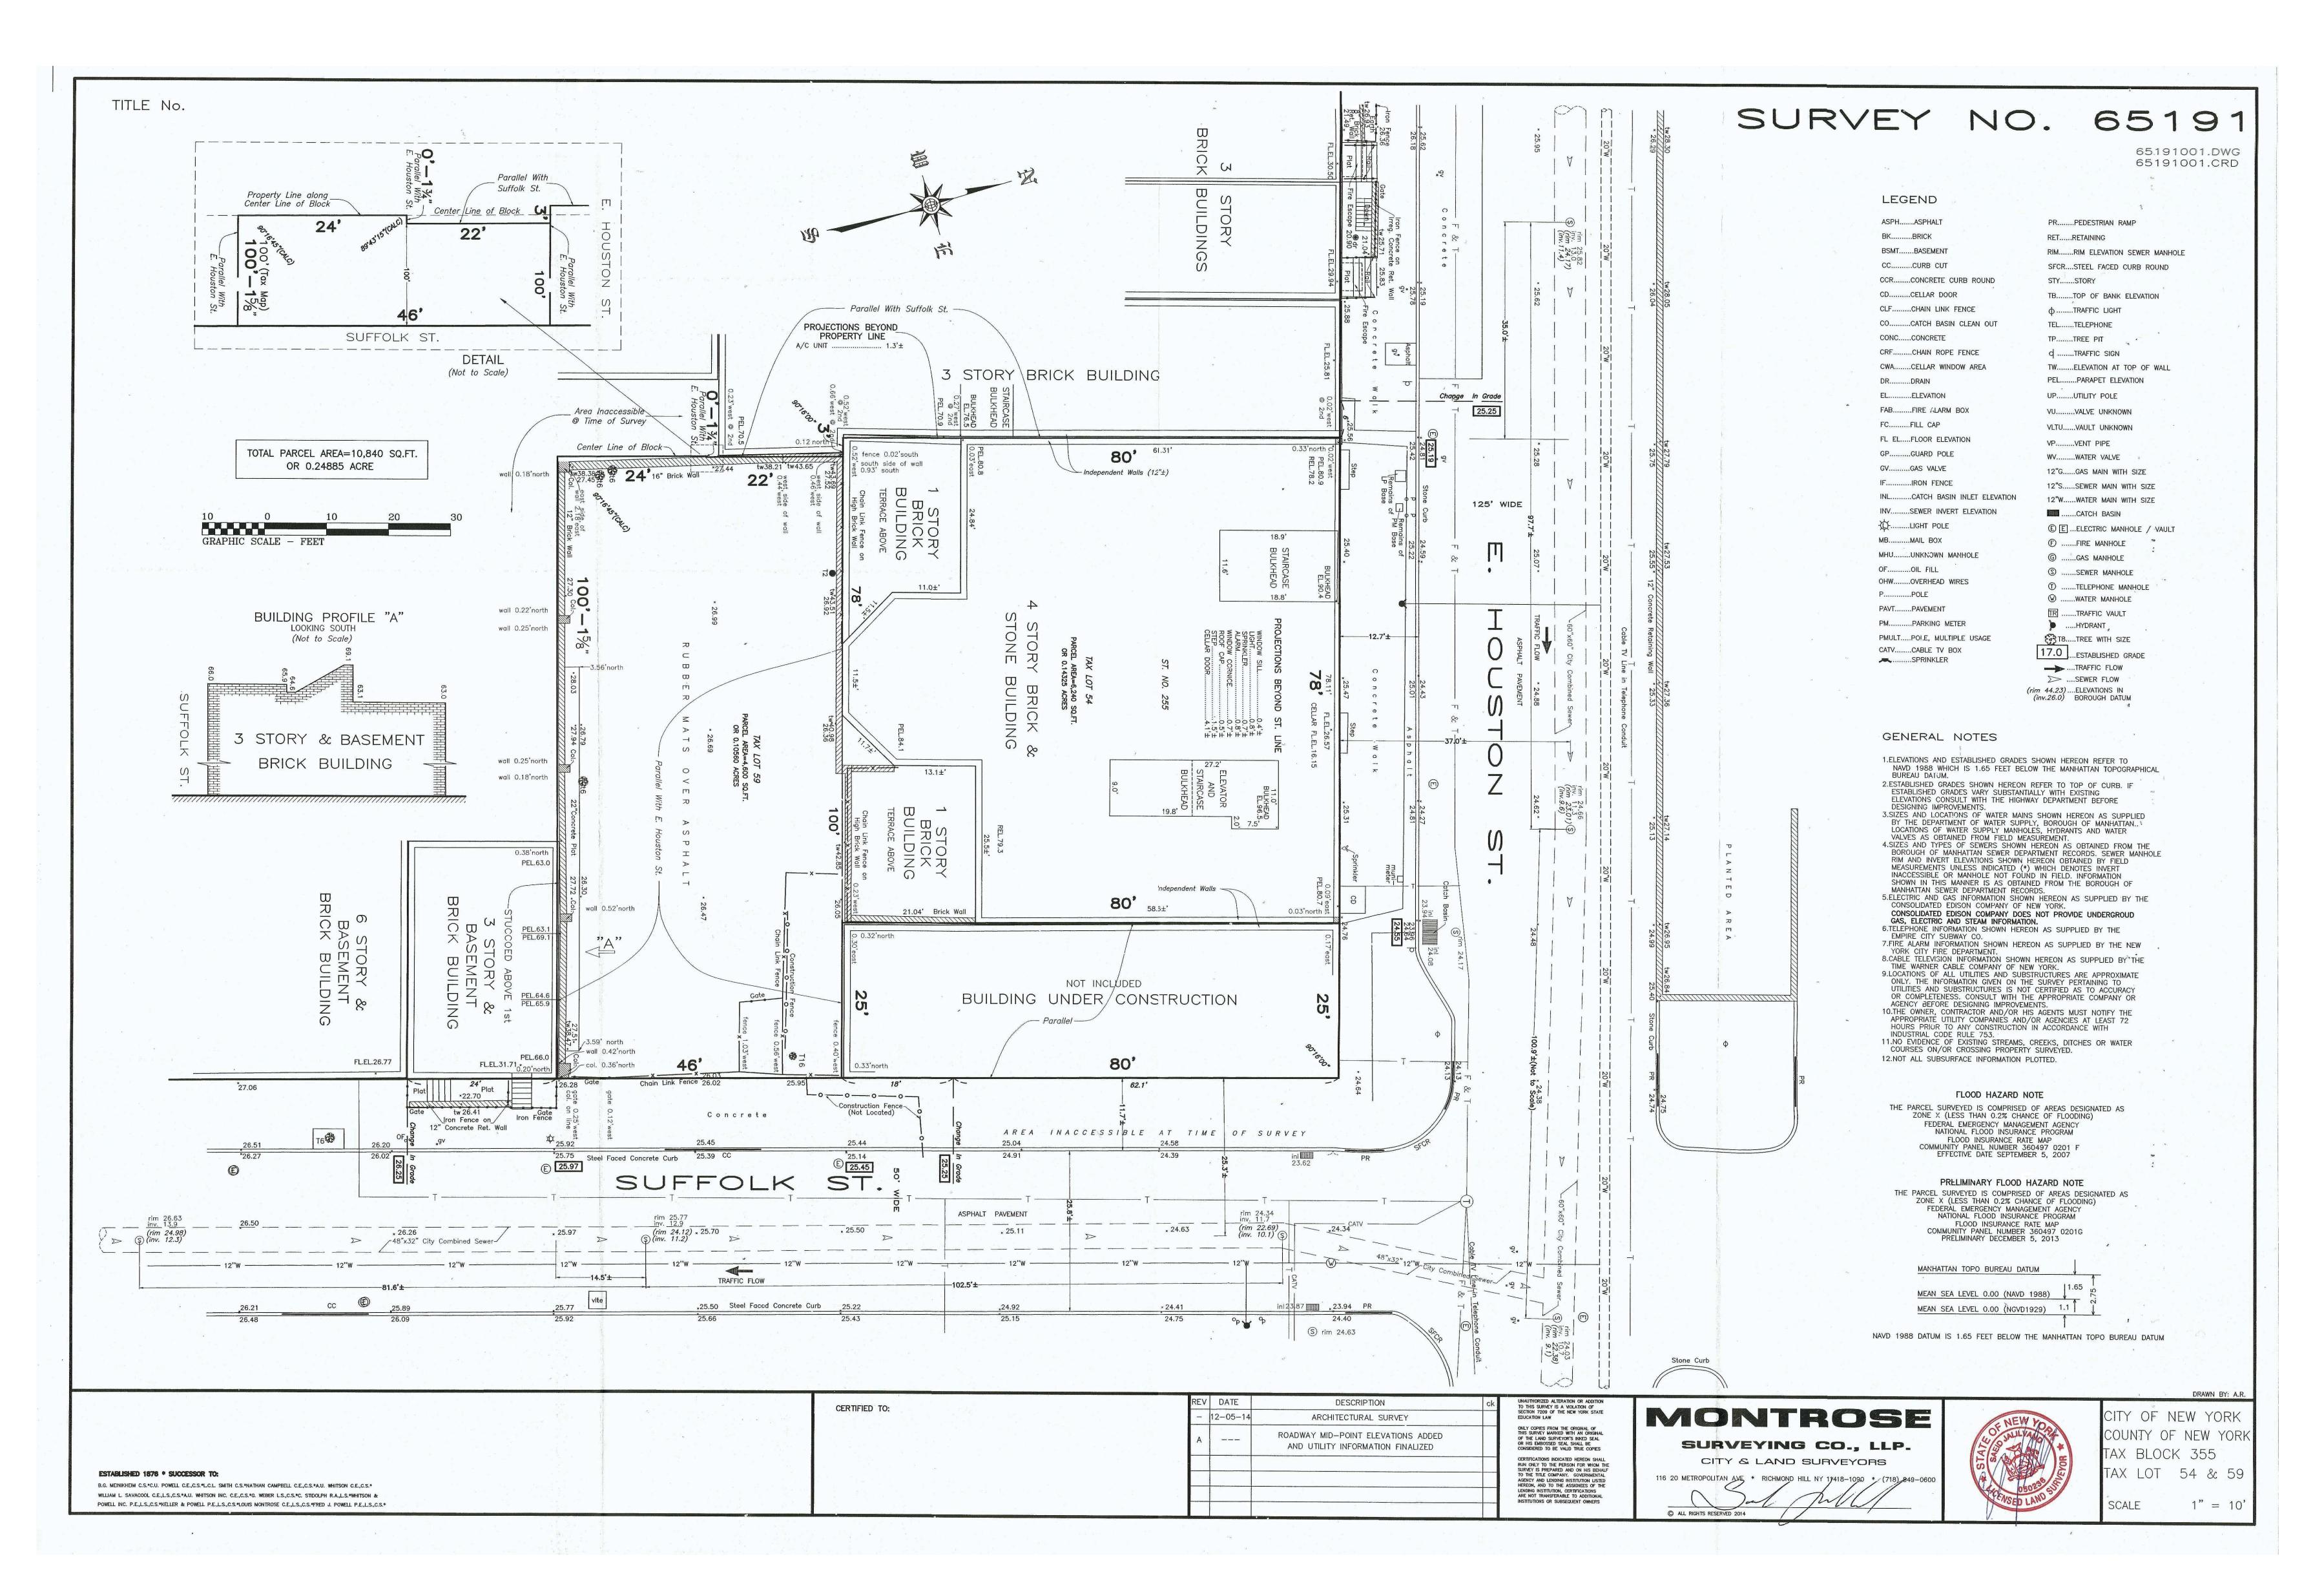
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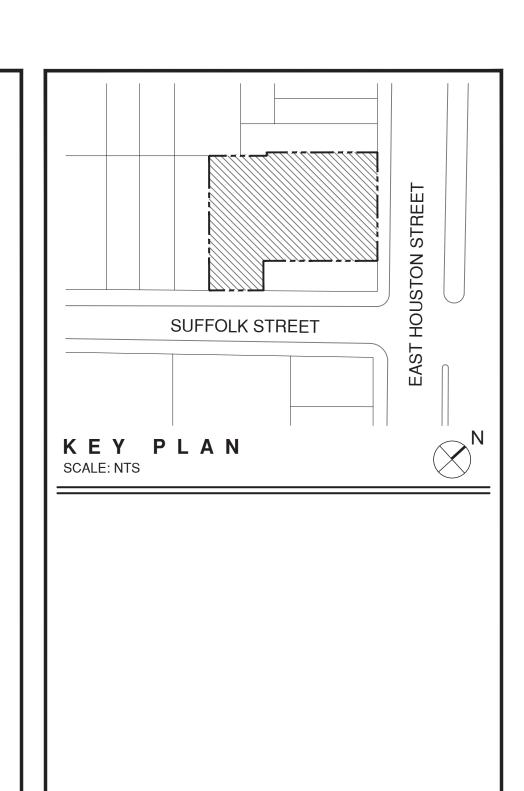
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SITE PLAN





1 PRE-CONSTRUCTION SURVEY
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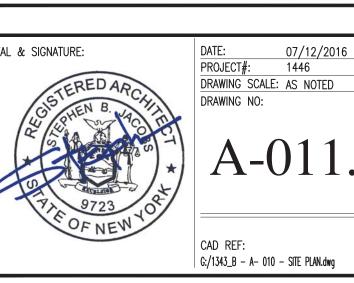
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PRE-CONSUCTION SURVEY

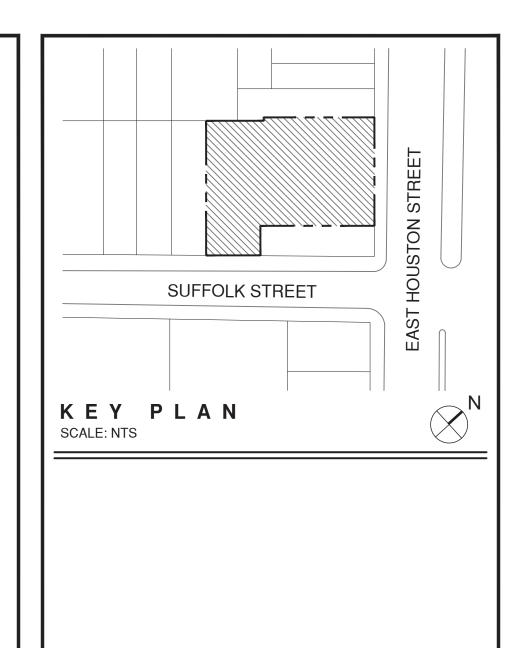

5 OF 40

ENCLOSURES ARE CONSTRUCTED AS SMOKEPROOF ENCLOSURES IN ACCORDANCE w. BC 1022.9. SEE ALSO BC 403.5.4

PROVIDED: YES BC 403.4.7.3 STANDBY POWER REQUIRED FOR R-2 OCCUPANCIES GREATER THAN 125' **BUILDING HEIGHT 140'-0" ; PROVIDED: YES**

BC 403.5.3 STAIRWAY DOOR OPERATION A DOOR LOCKED FROM THE STAIR SIDE MAY BE PERMITTED PROVIDED THAT SUCH DOOR IS EQUIPPED WITH AN AUTOMATIC FAIL SAFE SYSTEM FOR OPENING IN THE EVENT OF THE ACTIVATION OF ANY AUTOMATIC FIRE DETECTION SYSTEM, OR WHEN ANY ELEVATOR RECALL IS ACTIVATED, OR WHEN ANY SIGNAL IS RECEIVED FROM THE FIRE COMMAND CENTER.

PROVIDED: YES - DOORS ARE EQUIPPED w. AN AUTOMATIC FAIL SAFE SYSTEM BC 403.5.4 SMOKEPROOF EXIT ENCLOSURES EVERY REQUIRED STAIRWAY SERVING OCCUPIED FLOORS MORE THAN 75 FEET ABOVE THE LOWEST LEVEL OF FIRE DEPARTMENT VEHICLE ACCESS SHALL COMPLY WITH BC 909.20 AND BC 1022.9

> SMOKEPROOF ENCLOSURES WHERE REQUIRED BY BC 1022.9, A SMOKE PROOF ENCLOSURE SHALL BE CONSTRUCTED IN ACCORDANCE WITH THIS SECTION. WHERE ACCESS TO THE ROOF IS REQUIRED BY THE NEW YORK CITY FIRE CODE, SUCH ACCESS SHALL BE FROM THE SMOKE PROOF ENCLOSURE WHERE A SMOKE PROOF ENCLOSURE IS REQUIRED. SMOKEPROOF ENCLOSURES SHALL CONSIST OF ONE OF THE FOLLOWING SYSTEMS:

4. A PRESSURIZED INTERIOR EXIT STAIRWAY CONSTRUCTED IN ACCORDANCE WITH BC 1022.1. PROVIDED: YES - INTERIOR EXIT STAIRWAYS ARE PRESSURIZED BC 403.5.1 REMOTENESS OF EXIT STAIRWAY ENCLOSURES

BC 909.20

BC 403.6.1

N/A-EXCEPTION: GROUP R-2 OCCUPANCIES BC 403.5.3 STAIRWAY DOOR OPERATION A DOOR LOCKED FROM THE STAIR SIDE MAY BE PERMITTED PROVIDED THAT SUCH DOOR IS EQUIPPED WITH AN AUTOMATIC FAIL SAFE SYSTEM FOR OPENING IN THE EVENT OF THE ACTIVATION OF ANY AUTOMATIC FIRE DETECTION SYSTEM, OR WHEN ANY ELEVATOR RECALL IS ACTIVATED, OR WHEN ANY SIGNAL IS RECEIVED FROM THE FIRE COMMAND CENTER. SUCH DOOR SHALL BE DEEMED AS OPENABLE FROM THE STAIR SIDE. STAIR REENTRY SIGNS SHALL BE POSTED THROUGHOUT THE STAIRWAY INDICATING THAT

REENTRY IS PROVIDED ONLY DURING FIRE EMERGENCIES. SUCH SIGNS SHALL BE IN ACCORDANCE WITH BC 1030.4.2 PROVIDED: YES - EXIT STAIRWAY DOORS ARE EQUIPPED w. AUTOMATIC FAIL SAFE SYSTEM. BC 403.5.3.1 STAIRWAY COMMUNICATION SYSTEM

A TELEPHONE OR OTHER TWO-WAY COMMUNICATIONS SYSTEM CONNECTED TO AN APPROVED CONSTANTLY ATTENDED STATION SHAL BE PROVIDED AT NOT LESS THAN EVERY FIFTH FLOOR IN EACH STAIRWAY WHERE THE DOORS TO THE STAIRWAY ARE LOCKED IN ACCORDANCE TO BC 403.5.3 PROVIDED: YES - TWO-WAY COMMUNICATIONS SYSTEM WILL BE PROVIDED BC 403.5.5 LUMINOUS EGRESS PATH MARKINGS

N/A-EXCEPTION: GROUP R-2 OCCUPANCIES FIRE SERVICE ACCESS ELEVATOR

IN BUILDINGS w. AN OCCUPIED FLOOR MORE THAN 120 FEET ABOVE THE LOWEST LEVEL OF FIRE DEPARTMENT VEHICLE ACCESS, A MINIMUM OF ONE FIRE SERVICE ACCESS ELEVATOR SHALL BE PROVIDED IN ACCORDANCE W. BC PROVIDED: YES - BUILDING HEIGHT 137'-0"

FIRE SERVICE ELEVATOR LOBBY IN BUILDINGS WITH AN OCCUPIED FLOOR MORE THAN 120 FEET ABOVE THE LOWEST LEVEL OF FIRE DEPARTMENT VEHICLE ACCESS. A MINIMUM OF ONE FIRE SERVICE ACCESS ELEVATOR TO BE PROVIDED PER BC 3007. PROVIDED: NO; PER 3007.6, EXCEPTION 2:

2. A FIRE SERVICE ACCESS ELEVATOR LOBBY SHALL NOT BE REQUIRED ON STORIES WITH THE ELEVATOR OPENING TO A CORRIDOR ENCLOSED WITH A FIRE BARRIER, PROVIDED ALL DOORS OPENING INTO THE CORRIDOR ARE SMOKE & DRAFT CONTROLLED DOORS PER BC 715.4.3.1, TESTED PER UL 1784 TEST CONDUCTED WITHOUT THE ARTIFICIAL BOTTOM SEAL PROVIDED: YES - ALL CORRIDOR DOORS, INCLUDING ELEVATOR DOORS, ARE SMOKE & DRAFT CONTROLLED DOORS IN COMPLIANCE WITH BC 715.4.3.1

PROVIDED: YES - ALL FLRS. SERVED BY ELEVATORS ARE R-2 OCCUPANCY

BC 403.6.3 ELEVATOR LOBBIES ELEVATOR LOBBIES SHALL BE PROVIDED IN ACCORDANCE WITH BC 708.14.1 AND BC 708.14.2. PROVIDED: NO; PER 708.14.1, EXCEPTION 5: 5. ENCLOSED ELEVATOR LOBBIES ARE NOT REQUIRED ON GROUP R-2 OCCUPIED FLOORS.

GENERAL HEIGHT AND AREA LIMITATIONS; BC 503
 TABLE 503
 PROPOSED BUILDING IS CONSTRUCTION TYPE
 IB NON COMBUSTIBLE 2HR PROTECTED CONSTRUCTION GROUP HT (feet)

> R-2 A (area/story) UL | e: WHEN BUILDINGS ARE EQUIPPED THROUGHOUT WITH AN APPROVED AUTOMATIC SPRINKLER SYSTEM IN ACCORDANCE WITH BC 903.3.1.1. SHALL

BE UNLIMITED IN HEIGHT MIXED USE AND OCCUPANCY; BC 508

ACCESSORY OCCUPANCIES BC 508.2 ACCESSORY OCCUPANCIES ARE THOSE OCCUPANCIES THAT ARE ANCILLARY TO THE MAIN OCCUPANCY OF THE BUILDING OR PORTION THEREOF. ACCESSORY OCCUPANCIES SHALL COMPLY WITH THE PROVISIONS OF BC 508.2.1 THRU BC 508.2.4

BC 508.2.1 **AREA LIMITATIONS** AGGREGATE ACCESSORY OCCUPANCIES SHALL NOT OCCUPY AREA LIMITATIONS. MORE THAN 10 PERCENT OF THE BUILDING AREA OF THE STORY IN WHICH THEY ARE LOCATED AND SHALL NOT EXCEED THE TABULAR VALUES IN TABLE 503, WITHOUT BUILDING AREA INCREASES IN ACCORDANCE WITH BC 506 FOR SUCH ACCESSORY OCCUPANCIES.

BC 508.2.2 OCCUPANCY CLASSIFICATION ACCESSORY OCCUPANCIES SHALL BE INDIVIDUALLY CLASSIFIED IN ACCORDANCE WITH BC 302.1. THE REQUIREMENTS OF THIS CODE SHALL APPLY TO EACH PORTION OF THE BUILDING BASED ON THE OCCUPANCY CLASSIFICATION OF THAT SPACE.

BC 508.2.4 SEPARATION OF OCCUPANCY NO SEPARATION IS REQUIRED BETWEEN ACCESSORY OCCUPANCIES AND THE

BC 508.3.1 NON-SEPARATED OCCUPANCY CLASSIFICATION NON-SEPARATED OCCUPANCIES SHALL BE INDIVIDUALLY CLASSIFIED IN ACCORDANCE WITH BC 302.1. THE REQUIREMENTS OF THIS CODE SHALL APPLY TO EACH PORTION OF THE BUILDING BASED ON THE OCCUPANCY CLASSIFICATION OF THAT SPACE.

BC 508.3.1 NON-SEPARATED OCCUPANCY CLASSIFICATION (CON'T) IN ADDITION, THE MOST RESTRICTIVE PROVISIONS OF BC CH. 9 WHICH APPLY TO THE NON-SEPARATED OCCUPANCIES SHALL APPLY TO THE TOTAL NON-SEPARATED OCCUPANCY AREA. WHERE NON-SEPARATED OCCUPANCIES OCCUR IN A HIGH-RISE BUILDING, THE MOST RESTRICTIVE REQUIREMENTS OF BC 403 WHICH APPLY TO THE NON-SEPARATED OCCUPANCIES SHALL APPLY THROUGHOUT THE HIGH-RISE BUILDING.

SEPARATED OCCUPANCIES BC 508.4 BUILDINGS OR PORTIONS OF BUILDINGS THAT COMPLY WITH THE PROVISIONS OF THIS SECTION SHALL BE CONSIDERED AS SEPARATED OCCUPANCIES..

TABLE 508.4 USE B S-2 U REQUIRED SEPARATION OF OCCUPANCIES (HOURS)

PROVIDED: YES - FIRE RATED WALLS PROVIDED & BUILDING IS FULLY SPRINKLERED **INCIDENTAL USES; BC 509**

ROOM OR AREA SEPARATION ROOMS w. A HIGH PRESSURE STEAM 2 HOUR; OR 1 HOUR & PROVIDE AUTOMATIC FIRE-EXTINGUISHING OR WATER BOILER THAT EXCEEDS 350,000 BTU PER HOUR INPUT PROVIDED: YES - 1HR & SPRINKLER ROOMS CONTAINING FIRE PUMPS IN | 2 HOUR HIGH-RISE BUILDINGS PROVIDED; 2HR & SPRINKLER; YES

INCIDENTAL USES LISTED IN TABLE 509 AND LOCATED WITHIN SINGLE OCCUPANCY OR MIXED OCCUPANCY BUILDINGS SHALL COMPLY WITH THE PROVISIONS OF THIS SECTION. INCIDENTAL USES ARE ANCILLARY FUNCTIONS ASSOCIATED WITH A GIVEN OCCUPANCY THAT GENERALLY POSE A GREATER LEVEL OF RISK TO THAT OCCUPANCY AND ARE LIMITED TO THOSE USES LISTED IN TABLE 509

OCCUPANCY CLASSIFICATION INCIDENTAL USES SHALL NOT BE INDIVIDUALLY CLASSIFIED IN ACCORDANCE WITH SECTION 302.1. INCIDENTAL USES SHALL BE INCLUDED IN THE BUILDING OCCUPANCIES WITHIN WHICH THEY ARE LOCATED. SEPARATION

BUILDING IN WHICH THEY ARE LOCATED. SEPARATION AND PROTECTION THE INCIDENTAL USES LISTED IN TABLE 509 SHALL BE SEPARATED FROM THE REMAINDER OF THE BUILDING OR EQUIPPED WITH AN AUTOMATIC SPRINKLER

INCIDENTAL USES SHALL NOT OCCUPY MORE THAN 10 PERCENT OF THE

SYSTEM, OR BOTH, IN ACCORDANCE WITH THE PROVISIONS OF THAT TABLE. BC 509.4.1 SEPARATION WHERE TABLE 509 SPECIFIES A FIRE-RESISTANCE-RATED SEPARATION. THE INCIDENTAL USES SHALL BE SEPARATED FROM THE REMAINDER OF THE BUILDING BY A FIRE BARRIER CONSTRUCTED IN ACCORDANCE WITH SECTION 707 OR A HORIZONTAL ASSEMBLY CONSTRUCTED IN ACCORDANCE WITH

TYPE IB CLASSIFICATION; BC 601

SECTION 712, OR BOTH.

AREA LIMITATIONS

BC 509.3

TABLE 601 FIRE-RESISTANCE RATING REQUIRED FOR BUILDING FLEMENTS (HOURS)

BUILDING ELEMENT		TYPE I
BOILDING LLLWLN1		В
STRUCTURAL FRAME, IN GIRDERS, TRUSSES	CLUDING COLUMNS*,	2, *3 FOR COLUMNS AS PER 403.2.1
	EXTERIOR	2
BEARING WALLS	INTERIOR	2
NONBEARING WALLS	EXTERIOR	SEE TABLE 602
AND PARTITIONS	INTERIOR	0
INTERIOR SUPPORTING	FLOOR CONSTRUCTION	2
BEAMS AND JOISTS	ROOF CONSTRUCTION	1

TABLE 602 FIRE-RESISTANCE RATING REQUIREMENTS FOR EXTERIOR WALLS BASED ON FIRE SEPARATION DISTANCE FIRE SEPARATION OCCUPANCY GROUP CONSTRUCTION **DISTANCE (FEET)** B, R-2, S-2, U $5 \le X < 10$ OTHERS 10 ≤ X < 30

EXTERIOR WALLS; BC 705 THE MAXIMUM AREA OF UNPROTECTED AND PROTECTED OPENINGS

EXCEED THE PERCENTAGES SPECIFIED IN TABLE 705.8 TABLE 705.8 MAXIMUM AREA OF EXTERIOR WALL OPENINGS BASED ON FIRE SEPARATION DISTANCE AND DEGREE OF OPENING PROTECTION

PERMITTED IN AN EXTERIOR WALL IN ANY STORY OF A BUILDING SHALL NOT

FIRE SEPARATION DISTANCE (FEET)							
CLASSIFICATION OF OPENING	PROTECTED						
0 < X ≤ 3	NOT PERMITTED						
3 < X ≤ 5	15%						
5 < X ≤ 10	25%						
10 < X ≤ 15	45%						
15 < X ≤ 20	75%						
20 < X ≤ 25	NO LIMIT						

FIRE WALLS; BC 706

TABLE 706.4 FIRE WALL RESISTANCE RATINGS FIRE-RESISTANCE RATING (HOURS) A. B. E. H-4. I. R-1. R-2. U F-1, H-3b, H-5, M, S-1 H-1, H-2

SHAFT ENCLOSURES; BC 708

BC 708.12.1 SMOKE VENTING OF STAIR AND OTHER CLOSED SHAFTS ALL CLOSED SHAFTS, INCLUDING VERTICAL EXIT ENCLOSURES, HAVING A FLOOR AREA EXCEEDING 4 SQUARE FEET SHALL BE PROVIDED WITH A SMOKE VENT IN ACCORDANCE WITH SECTIONS 708.12.1.1 THROUGH 708.12.1.3 PROVIDED - YES

SMOKE AND HEAT VENTS; BC 910

BC 910.3.4 VENT LOCATION SMOKE AND HEAT VENTS SHALL BE LOCATED 20 FEET OR MORE FROM ADJACENT LOT LINES AND FIRE WALLS AND 10 FEET OR MORE FROM FIRE BARRIERS, VENTS SHALL BE UNIFORMLY LOCATED WITHIN THE ROOF IN THE AREAS OF THE BUILDING WHERE THE VENTS ARE REQUIRED TO BE INSTALLED BY SECTION 28.2-910.2. WITH CONSIDERATION GIVEN TO ROOF PITCH. DRAFT CURTAIN LOCATION, SPRINKLER LOCATION AND STRUCTURAL MEMBERS. PROVIDED - YES

BC 1004.1.1 AREAS WITHOUT FIXED SEATING THE NUMBER OF OCCUPANTS SHALL BE COMPUTED AT THE RATE OF ONE OCCUPANT PER UNIT OF AREA AS PRESCRIBED IN TABLE 1004.1.1. TABLE 1004.1.1 MAXIMUM FLOOR AREA ALLOWANCES PER OCCUPANT

FUNCTION OF SPACE FLOOR AREA (S.F.) / OCCUPANT RESIDENTIAL (R-2) 200 GROSS within DWELLING UNIT BUSINESS AREAS (B) 100 GROSS EXERCISE ROOMS (ACC. TO R-2) 50 GROSS ACC. STORAGE. MECH. EQUIP. RMS. 300 GROSS STORAGE (S-2) 300 GROSS

EGRESS WIDTH; BC 1005

OCCUPANT LOAD; BC 1004

MINIMUM REQUIRED EGRESS WIDTH THE MEANS OF EGRESS WIDTH SHALL NOT BE LESS THAN THAT REQUIRED BY THIS SECTION. THE TOTAL WIDTH OF MEANS OF EGRESS IN INCHES SHALL NOT BE LESS THAN THE TOTAL OCCUPANT LOAD SERVED BY THE MEANS OF EGRESS MULTIPLIED BY 0.3 INCHES PER OCCUPANT FOR STAIRWAYS AND BY 0.2 INCHES PER OCCUPANT FOR OTHER EGRESS COMPONENTS. THE WIDTH SHALL NOT BE LESS THAN SPECIFIED ELSEWHERE IN THIS CODE. MULTIPLE MEANS OF EGRESS SHALL BE SIZED SUCH THAT THE LOSS OF ANY ONE MEANS OF EGRESS SHALL NOT REDUCE THE AVAILABLE CAPACITY TO LESS THAN 50 PERCENT OF THE REQUIRED CAPACITY. THE MAXIMUM CAPACITY REQUIRED FROM ANY STORY OF A BUILDING SHALL BE MAINTAINED TO THE TERMINATION OF THE MEANS OF EGRESS

BC 1008.1.6 **LANDINGS AT DOORS** LANDINGS SHALL HAVE A WIDTH NOT LESS THAN THE WIDTH OF THE STAIRWAY

OR THE DOOR, WHICHEVER IS GREATER. DOORS IN THE FULLY OPEN POSITION SHALL NOT REDUCE A REQUIRED DIMENSION BY MORE THAN 7 INCHES. AT ANY STAIRWAY LANDING, OR WHEN A DOOR LANDING SERVES AN OCCUPANT LOAD OF 50 OR MORE, DOORS IN ANY POSITION SHALL NOT REDUCE THE LANDING TO LESS THAN 75 PERCENT OF ITS REQUIRED WIDTH, LANDINGS SHALL HAVE A LENGTH MEASURED IN THE DIRECTION OF TRAVEL OF NOT LESS THAN 44

STAIRWAYS; BC 1009

BC 1009.1 STAIRWAY WIDTH THE WIDTH OF STAIRWAYS SHALL BE DETERMINED AS SPECIFIED IN SECTION 1005.1, BUT SUCH WIDTH SHALL NOT BE LESS THAN 44 INCHES. PROVIDED: YES

HEADROOM BC 1009.2 STAIRWAYS SHALL HAVE A MINIMUM HEADROOM CLEARANCE OF 84 INCHES MEASURED VERTICALLY FROM A LINE CONNECTING THE EDGE OF THE NOSINGS. SUCH HEADROOM SHALL BE CONTINUOUS ABOVE THE STAIRWAY TO THE POINT WHERE THE LINE INTERSECTS THE LANDING BELOW, ONE TREAD DEPTH BEYOND THE BOTTOM RISER. THE MINIMUM CLEARANCE SHALL BE MAINTAINED THE FULL WIDTH OF THE STAIRWAY & LANDING, PROJECTIONS INTO THE REQUIRED WIDTH SHALL NOT BE LIMITED ABOVE THE MINIMUM **HEADROOM HEIGHT EXCEPTIONS:**

1. IN GROUP R-2 & R-3 OCCUPANCIES. STAIRWAYS SHALL HAVE A MINIMUM HEADROOM CLEARANCE OF 80 INCHES PROVIDED: YES

BC 1009.4.2 RISER HEIGHT AND TREAD DEPTH STAIR RISER HEIGHTS SHALL BE 7 INCHES MAXIMUM AND 4 INCHES MINIMUM. 5.2 IN GROUP R-2 OCCUPANCIES: THE MAXIMUM RISER HEIGHT SHALL BE 7³/₄ INCHES, AND THE MINIMUM TREAD DEPTH SHALL BE 91/2 INCHES PLUS

EXIT ACCESS; BC 1009

COMMON PATH OF EGRESS TRAVEL IN OCCUPANCIES OTHER THAN GROUPS H-1, H-2 AND H-3, THE COMMON PATH OF EGRESS TRAVEL SHALL NOT EXCEED 75 FEET.

2. WHERE A TENANT SPACE IN GROUP B, S & U OCCUPANCIES HAS AN OCCUPANT LOAD OF NOT MORE THAN 30, THE LENGTH OF A COMMON PATH OF EGRESS TRAVEL IN GROUP B, F & S OCCUPANCIES SHALL NOT BE MORE THAN 100 FT THE LENGTH OF A COMMON PATH OF EGRESS TRAVEL IN A GROUP R-2.

OCCUPANCY SHALL NOT BE MORE THAN 125 FT. PROVIDED THAT THE

SYSTEM INSTALLED IN ACCORDANCE WITH BC 903.1.1 OR BC 903.1.2

BUILDING IS EQUIPPED THROUGHOUT WITH AN AUTOMATIC SPRINKLER

EXIT AND EXIT ACCESS DOORWAYS; BC 1015

BC 1015.2.1 TWO EXITS OR EXIT ACCESS DOORWAYS WHERE TWO EXITS OR EXIT ACCESS DOORWAYS ARE REQUIRED FROM ANY PORTION OF THE EXIT ACCESS, THE EXIT DOORS OR EXIT ACCESS DOORWAYS SHALL BE PLACED A DISTANCE APART EQUAL TO NOT LESS THAN ONE-HALF OF THE LENGTH OF THE MAXIMUM OVERALL DIAGONAL DIMENSION OF THE BUILDING OR AREA TO BE SERVED MEASURED IN A STRAIGHT LINE BETWEEN EXIT DOORS OR EXIT ACCESS DOORWAYS.

EXCEPTIONS: 8. R-2 OCCUPANCIES IN GROUP R-2 OCCUPANCIES, WHERE STAIRS ARE ENCLOSED IN WALLS HAVING AT LEAST 2-HOUR FIRE-RESISTANCE RATING AND CONSTRUCTED OF MASONRY OR MASONRY EQUIVALENT IN ACCORDANCE w. **DEPARTMENT RULES:** 3.1 THE EXIT DOORS TO SUCH STAIRS SHALL BE PLACED A DISTANCE

APART EQUAL TO NO LESS THAN 15 FEET 3.2 SUCH STAIRS SHALL BE PERMITTED TO SHARE COMMON WALLS, FLOORS. CEILINGS OR SCISSOR STAIR ASSEMBLIES OR OTHER ENCLOSURES PROVIDED THAT THE CONSTRUCTION SEPARATING THE STAIRS IS ALSO OF AT LEAST 2-HOUR FIRE-RESISTANCE RATING AND CONSTRUCTED OF MASONRY OR MASONRY EQUIVALENT IN ACCORDANCE W. DEPARTMENT RULES.

EXIT ACCESS TRAVEL DISTANCE; BC 1016

TRAVEL DISTANCE LIMITATIONS EXITS SHALL BE SO LOCATED ON EACH STORY SUCH THAT THE MAXIMUM LENGTH OF EXIT ACCESS TRAVEL, MEASURED FROM THE MOST REMOTE POINT WITHIN A STORY ALONG THE NATURAL AND UNOBSTRUCTED PATH OF EGRESS TRAVEL TO AN EXTERIOR EXIT DOOR AT THE LEVEL OF EXIT DISCHARGE, AN ENTRANCE TO A VERTICAL EXIT ENCLOSURE. AN EXIT PASSAGEWAY. A HORIZONTAL EXIT, AN EXTERIOR EXIT STAIRWAY OR AN EXTERIOR EXIT RAMP.

SHALL NOT EXCEED THE DISTANCES GIVEN IN TABLE 1016.1 TABLE 1016.1 EXIT ACCESS TRAVEL DISTANCE **OCCUPANCY** WITH SPRINKLER SYSTEM (FEET E, F-1, M, R, S-1 200^b

c. BUILDINGS EQUIPPED THROUGHOUT WITH AN AUTOMATIC SPRINKLER

F-2, S-2, U b. BUILDINGS EQUIPPED THROUGHOUT WITH AN AUTOMATIC SPRINKLER SYSTEM IN ACCORDANCE WITH BC 903.3.1.1 OR BC 903.3.1.2. SEE BC 903 FOR OCCUPANCIES WHERE SPRINKLER SYSTEMS ACCORDING TO BC 903.3.1.2 ARE PERMITTED

CORRIDORS; BC 1018

BC 1018.1 CONSTRUCTION CORRIDORS SHALL BE CONSTRUCTED IN ACCORDANCE WITH THIS SECTION. INTERIOR CORRIDOR WALLS REQUIRED TO BE FIRE-RESISTANCE RATED SHALL COMPLY WITH SECTION 709 FOR FIRE PARTITIONS. PUBLIC CORRIDOR WALLS

SHALL COMPLY WITH SECTION 707 FOR FIRE BARRIERS

SYSTEM IN ACCORDANCE WITH BC 903.3.1.1

BC 1018.1.2 PUBLIC CORRIDORS PUBLIC CORRIDORS SHALL BE FIRE-RESISTANCE RATED IN ACCORDANCE WITH

TABLE 1018.1.2 PUBLIC CORRIDOR FIRE-RESISTANCE RATING **FIRE-RESISTANCE RATING (HOURS)** A, E, M, S, U

R (NON-COMBUSTIBLE BC 1018.4 **DEAD ENDS**

WHERE MORE THAN ONE EXIT OR EXIT ACCESS DOORWAY IS REQUIRED, THE EXIT ACCESS SHALL BE ARRANGED SUCH THAT THERE ARE NO DEAD ENDS IN CORRIDORS MORE THAN 20 FEET IN LENGTH **EXCEPTIONS:**

4. IN OCCUPANCIES IN GROUP R-2. THE DEAD END CORRIDOR SHALL NOT EXCEED 40 FEET. HOWEVER, WHERE SUCH CORRIDORS ARE COMPLETELY ENCLOSED IN IN CONSTRUCTION HAVING A 2-HOUR FIRE-RESISTANCE RATING WITH ALL DOORS OPENING INTO THE CORRIDOR BEING SELF-CLOSING AND HAVING A FIRE-RESISTANCE RATING OF 11/2 HOURS THE LENGTH OF THE DEAD END CORRIDOR SHALL NOT EXCEED 80 FEET.

EXIT PASSAGEWAYS; BC 1023 BC 1023.1

EXIT PASSAGEWAY EXIT PASSAGEWAYS SERVING AS AN EXIT COMPONENT IN A MEANS OF EGRESS SYSTEM SHALL COMPLY WITH THE REQUIREMENTS OF THIS SECTION. AN EXIT PASSAGEWAY SHALL NOT BE USED FOR ANY PURPOSE OTHER THAN AS A MEANS OF EGRESS.

BC 1023.2 THE WIDTH OF EXIT PASSAGEWAYS SHALL BE DETERMINED AS SPECIFIED IN SECTION 1005.1 BUT SUCH WIDTH SHALL NOT BE LESS THAN 44 INCHES. EXCEPT THAT EXIT PASSAGEWAYS SERVING AN OCCUPANT LOAD OF LESS THAN 50 SHALL NOT BE LESS THAN 36 INCHES IN WIDTH. THE REQUIRED WIDTH

OF EXIT PASSAGEWAYS SHALL BE UNOBSTRUCTED.

SHAFT ENCLOSURES; BC 708

BC 708.12.1 SMOKE VENTING OF STAIR AND OTHER CLOSED SHAFTS ALL CLOSED SHAFTS. INCLUDING VERTICAL EXIT ENCLOSURES. HAVING A FLOOR AREA EXCEEDING 4 SQUARE FEET SHALL BE PROVIDED WITH A SMOKE VENT IN ACCORDANCE WITH SECTIONS 708.12.1.1 THROUGH 708.12.1.3 PROVIDED - YES

MINIMUM PLUMBING FACILITIES; PC 403

TABLE 403.1 MI

MINIMUM NUMBER OF REQUIRED PLUMBING FIXTURES											
CLASS.	OCC	DESCRIPTION	W.C.		LAV.		BATH &	DRINK.	OTHERS	PROV	
	000.	DEGOINI HON	M.	F.	M.	F.	SHWR.	FTN.	OTTLING	I KOV.	
RESID.	R-2	APARTMENT HOME	1 per	D.U.	1 per	D.U.	1 per D.U.	1 per D.U.	1 KIT. SINK per D.U.	YES	
BUSINESS	В	BLDG. FOR BUSINESS TRANS.	1 per	1-20	1 per	1-20	1 per 1-25	SEE PC 411	1 SERVICE SINK	YES	

PC 403.2 SEPARATE FACILITIES WHERE PLUMBING FIXTURES ARE REQUIRED, SEPARATE FACILITIES SHALL BE PROVIDED FOR EACH SEX. **EXCEPTIONS:**

IN STRUCTURES OR TENANT SPACES WHERE COMBINED EMPLOYEE AND PUBLIC TOILET FACILITIES ARE PROVIDED IN ACCORDANCE w. PC 403.3, SEPARATE FACILITIES SHALL NOT BE REQUIRED WHERE THE TOTAL NUMBER OF EMPLOYEES, CUSTOMERS, PATRONS & VISITORS IS LESS **THAN 30**

OCCUPANCY LOAD & EGRESS CALCULATIONS

CELLAR OCCUPANT LOAD S-2 STORAGE (ACCESSORY to R-2)

ACCESSORY TO R-2 = 218 SF = 2 OCCUPANTS PROPOSED LAUNDRY ROOM = 266 SF = 1 OCCUPANT PROPOSED SUPER'S OFFICE / SHOP BIKE ROOM = 667 SF /300 = 2 OCCUPANTS **U UTILITY** (ACCESSORY to R-2) COMPACTOR ROOM = 266 SF /300 = 1 OCCUPANT M.E.R. 1 (HOUSTON SIDE) = 978 SF = 1 OCCUPANT PROPOSED M.E.R. 2 (SUFFOLK SIDE) = 409 SF = 1 OCCUPANT PROPOSED

= 4,483 SF /300 = 15 OCCUPANTS

TOTAL OCCUPANT LOAD = 15 + 8 = 23 OCCUPANTS**CELLAR EGRESS CALCULATIONS** PROVIDED WIDTH OF STAIRWAYS: $= 44 \times 3 = 132$ " TOTAL EGRESS CAPACITY OF 88" STAIRWAYS = 132 / 0.3 = 440 OCCUPANTS

1ST FLOOR OCCUPANT LOAD

CAPACITY REQUIRED = 23 < 440; OK

B BUSINESS = 4.041 SF /100 = 40 OCCUPANTS MEDICAL FACILITIES **ACCESSORY TO R-2** = 409 SF = 2 OCCUPANTS PROPOSED = 115 SF = 1 OCCUPANT PROPOSED PACKAGE ROOM MAILROOM & BATHROOM = 92 SF = 1 OCCUPANT PROPOSED INDOOR RECREATION SPACE = 1,425 SF = 15 OCCUPANTS PROPOSED OUTDOOR RECREATION SPACE = 1,368 SF = 15 OCCUPANTS PROPOSED

TOTAL OCCUPANT LOAD = 40 + 34 = 74 OCCUPANTS

1ST FLOOR RESIDENTIAL EGRESS CALCULATIONS 1ST FLOOR OCCUPANTS EGRESSING THRU LOBBY = 34 OCCUPANTS & SERVICE / DELIVERY CORRIDOR ON HOUSTON PROVIDED WIDTH OF SMALLEST COMPONENT (DOORS) = 98+36 = 134" TOTAL EGRESS CAPACITY / PER 134" DOORS = 134 / 0.2 = 670 OCCUPANTS CAPACITY REQUIRED = 34 < 670; OK

1ST FLOOR BUSINESS OCCUPANCY EGRESS CALCULATIONS OCCUPANTS EGRESSING THROUGH BUSINESS SPACE = 40 OCCUPANTS PROVIDED WIDTH OF SMALLEST COMPONENT (DOORS) = (2 X 72") + 36" = 180" TOTAL EGRESS CAPACITY OF 144" OF DOORS = 1480 / 0.2 = 900 OCCUPANTS CAPACITY REQUIRED = 40 < 900; OK

2ND FLOOR OCCUPANT LOAD

R-2 RESIDENTIAL DWELLING UNITS = 5055 SF /200 = 25 OCCUPANTS (TOTAL LOAD) 2ND FLOOR EGRESS CALCULATIONS PROVIDED WIDTH OF STAIRWAYS: $= 44" \times 2 = 88"$

TOTAL EGRESS CAPACITY OF 88" STAIRWAYS = 88" / 0.3 = 293 OCCUPANTS CAPACITY REQUIRED = 25 < 293; OK PROVIDED WIDTH OF SMALLEST COMPONENT (DOORS) = 2 x36" = 72" TOTAL EGRESS CAPACITY / PER 72" DOORS = 72 / 0.2 = 360 OCCUPANTS CAPACITY REQUIRED = 25 < 360; OK

3RD - 5TH FLOOR OCCUPANT LOAD

R-2 RESIDENTIAL = 5472 SF /200 = 27 OCCUPANTS DWELLING UNITS

(TOTAL LOAD) 3RD - 5TH FLOOR EGRESS CALCULATIONS PROVIDED WIDTH OF STAIRWAYS: = 44" x 2 = 88" TOTAL EGRESS CAPACITY OF 88" STAIRWAYS = 88" / 0.3 = 293 OCCUPANTS

CAPACITY REQUIRED = 27 < 293; OK PROVIDED WIDTH OF SMALLEST COMPONENT (DOORS) = 2 x36" = 72" TOTAL EGRESS CAPACITY / PER 72" DOORS = 72 / 0.2 = 360 OCCUPANTS CAPACITY REQUIRED = 27 < 360; OK

6TH - 7TH FLOOR OCCUPANT LOAD

R-2 RESIDENTIAL = 5465 SF /200 = 27 OCCUPANTS DWELLING UNITS (TOTAL LOAD) **6TH - 7TH FLOOR EGRESS CALCULATIONS** PROVIDED WIDTH OF STAIRWAYS: $= 44" \times 2 = 88"$ TOTAL EGRESS CAPACITY OF 88" STAIRWAYS = 88" / 0.3 = 293 OCCUPANTS CAPACITY REQUIRED = 27 < 293; OK

PROVIDED WIDTH OF SMALLEST COMPONENT (DOORS) = 2 x36" = 72"

TOTAL EGRESS CAPACITY / PER 72" DOORS = 72 / 0.2 = 360 OCCUPANTS

8TH FLOOR OCCUPANT LOAD

R-2 RESIDENTIAL = 4712 SF /200 = 24 OCCUPANTS DWELLING UNITS

8TH FLOOR EGRESS CALCULATIONS PROVIDED WIDTH OF STAIRWAYS:

CAPACITY REQUIRED = 27 < 360; OK

= 44" x 2 = 88" TOTAL EGRESS CAPACITY OF 88" STAIRWAYS = 88" / 0.3 = 293 OCCUPANTS CAPACITY REQUIRED = 24 < 293; OK PROVIDED WIDTH OF SMALLEST COMPONENT (DOORS) = 2 x36" = 72"

(TOTAL LOAD)

TOTAL EGRESS CAPACITY / PER 72" DOORS = 72 / 0.2 = 360 OCCUPANTS CAPACITY REQUIRED = 24 < 360; OK 9TH FLOOR OCCUPANT LOAD

R-2 RESIDENTIAL

= 3215 SF /200 = 16 OCCUPANTS DWELLING UNITS (TOTAL LOAD) **ACCESSORY TO R-2** ROOFTOP TERRACE = 1743 SF = 12 OCCUPANTS PROPOSED TOTAL OCCUPANT LOAD = 16 + 12 = 28 OCCUPANTS

9TH FLOOR EGRESS CALCULATIONS

PROVIDED WIDTH OF STAIRWAYS: $= 44" \times 2 = 88"$ TOTAL EGRESS CAPACITY OF 88" STAIRWAYS = 88" / 0.3 = 293 OCCUPANTS CAPACITY REQUIRED = 28 < 293; OK PROVIDED WIDTH OF SMALLEST COMPONENT (DOORS) = 2 x36" = 72" TOTAL EGRESS CAPACITY / PER 72" DOORS = 72 / 0.2 = 360 OCCUPANTS

= 2840 SF /200 = 14 OCCUPANTS

= 44" x 2 = 88"

(TOTAL LOAD)

10TH FLOOR OCCUPANT LOAD R-2 RESIDENTIAL

DWELLING UNITS 10TH FLOOR EGRESS CALCULATIONS

CAPACITY REQUIRED = 28 < 360; OK

= 44" x 2 = 88" PROVIDED WIDTH OF STAIRWAYS: TOTAL EGRESS CAPACITY OF 88" STAIRWAYS = 88" / 0.3 = 293 OCCUPANTS CAPACITY REQUIRED = 14 < 293: OK PROVIDED WIDTH OF SMALLEST COMPONENT (DOORS) = 2 x36" = 72"

TOTAL EGRESS CAPACITY / PER 72" DOORS = 72 / 0.2 = 360 OCCUPANTS

11TH - 13TH FLOOR OCCUPANT LOAD

PROVIDED WIDTH OF STAIRWAYS:

CAPACITY REQUIRED = 14 < 360: OK

R-2 RESIDENTIAL = 2508 SF /200 = 13 OCCUPANTS DWELLING UNITS (TOTAL LOAD) 11TH - 13TH FLOOR EGRESS CALCULATIONS

CAPACITY REQUIRED = 13 < 293; OK PROVIDED WIDTH OF SMALLEST COMPONENT (DOORS) = 2 x36" = 72" TOTAL EGRESS CAPACITY / PER 72" DOORS = 72 / 0.2 = 360 OCCUPANTS CAPACITY REQUIRED = 13 < 360; OK

TOTAL EGRESS CAPACITY OF 88" STAIRWAYS = 88" / 0.3 = 293 OCCUPANTS

14TH FLOOR OCCUPANT LOAD

ACCESSORY TO R-2 ELEVATOR LOBBY & REF. RM. = 123+33 = 253 SF = 2 OCCUPANTS PROPOSED AMENITY SPACE = 490 SF = 18 TERRACE = 2490 SF = 36 OCCUPANTS PROPOSED = 56 OCCUPANTS PROPOSED TOTAL OCCUPANT LOAD

14TH FLOOR & TERRACE EGRESS CALCULATIONS

CAPACITY REQUIRED = 56 < 360: OK

PROVIDED WIDTH OF STAIRWAYS: $= 44" \times 2 = 88"$ TOTAL EGRESS CAPACITY OF 88" STAIRWAYS = 88" / 0.3 = 293 OCCUPANTS CAPACITY REQUIRED = 56 < 293; OK PROVIDED WIDTH OF SMALLEST COMPONENT (DOORS) = 2 x36" = 72" TOTAL EGRESS CAPACITY / PER 72" DOORS = 72 / 0.2 = 360 OCCUPANTS HOUSING MAINTENANCE CODE

OWNER SHALL FILE REGISTRATION STATEMENT AS PER D26-41.01 AND D26-41.03 HMC.

OWNER SHALL PROVIDE A SIGN IDENTIFYING OWNER. MANAGEMENT AND SUPERINTENDENT AS PER D26-41.15.

3. FLOOR SIGNS SHALL BE PLACED AND MAINTAINED ON EACH FLOOR LEVEL AS PER D26-21.03 HMC.

HOUR RATED, SELF CLOSING WITH PEEPHOLES AS PER D26-20.01 HMC AND LOCKS AS PER D26-20.05 HMC.

MIRRORS IN ELEVATORS SHALL BE AS PER D26-20.03 HMC.

4. ALL APARTMENT ENTRANCE DOORS SHALL BE A MINIMUM 3/4

THE BUILDING'S HEATING AND HOT WATER SUPPLY SHALL COMPLY WITH D26-17.01, 17.03, 17.05 AND 17.07 HMC.

LIGHTING SHALL BE PROVIDED AS PER D26-19.03, D26-19.05, AND D26- 19.07 HMC. AND C26-605AC, C26-1203AC AND SECTION 26-35

8. GARBAGE COLLECTION AND STORAGE IN RECEPTACLES SHALL D26-14.05 HMC. COMPLY WITH D26-14.03.

9. U.S. MAIL SERVICE SHALL BE PROVIDED AS PER D26-21.01 HMC.

10. THE BUILDING STREET NUMBER SHALL BE DISPLAYED AS PER

11. JANITORIAL SERVICES SHALL BE PROVIDED AS PER D26-22.03

12. OWNER SHALL PAINT ALL PUBLIC PARTS OF A MULTIPLE DWELLING AS PER D26-12.01 HMC.

13. INTERIOR OF DWELLING UNITS SHALL BE CLEANED AS PER D11.05

15. DUTIES OF TENANTS SHALL BE AS PER D26-10.03 AND 10.05 HMC.

14. DUTIES OF OWNER SHALL BE AS PER D26-10.01 HMC.

16. OWNER'S RIGHT OF ACCESS SHALL BE AS PER D26-10.07 HMC. 17. EXTERMINATION AND RODENT ERADICATION SHALL BE AS PER

D26- 13.03 AND 13.05 HMC. 18. WATER SHALL BE SUPPLIED AS PER D26-15.01 &15.03 HMC.

19. THE PLUMBING AND DRAINAGE SYSTEM SHALL BE MAINTAINED AS PER D26-16.01 HMC.

20. DRAINAGE OF ROOFS AND COURT YARDS SHALL BE AS PER D26-16.03 HMC.

21. NATURAL LIGHT AND VENTILATION SHALL BE PROVIDED AS PER

22. SANITARY FACILITIES IN MULTIPLE DWELLINGS AND LIGHT AND VENTILATION FOR TOILET COMPARTMENTS SHALL BE AS PER D26- 31.01, 31.03, 31.05, 31.07 AND 31-11 HMC.

D26-30.01 AND 30.03 HMC FOR MULTIPLE DWELLINGS.

23. KITCHENS AND KITCHENETTES SHALL BE PROVIDED WITH PROPER FACILITIES, EQUIPMENT, LIGHTING, VENTILATION AND FIRE PROTECTION AS PER D26-32.01, 32.03, AND 32.05 HMC.

24. MINIMUM ROOM SIZES SHALL BE AS PER D26-33.01 AND MAXIMUM

MULTIPLE DWELLING LAW - GENERAL PROVISIONS

LIGHTING AND VENTILATION OF ROOMS SHALL BE AS PER SECTION 30, MDL.

OCCUPANCY SHALL BE AS PER D26-33.03.

2. SIZE OF ROOMS SHALL BE AS PER SECTION 31, MDL. 3. ALCOVES SHALL BE AS PER SECION 32, MDL.

PER SECTION 33, MDL. BUILDING ENTRANCE DOORS AND LIGHTS SHALL BE AS PER SECTION 35, MDL.

WINDOWS AND SKYLIGHTS FOR PUBLIC HALLS AND STAIRS SHALL BE AS PER SECTION 36, MDL.

4. COOKING SPACES (KITCHENS & KITCHENETTES) SHALL BE AS

8. ENTRANCE HALLS TO BE AS PER SECTION 50, MDL. 9. BUILDING ENTRANCE DOORS, LOCKS AND INTERCOMMUNICATIONAL SYSTEMS SHALL BE ASPER SECTION

ARTIFICIAL HALL LIGHTING SHALL BE AS PER SECTION 37, MDL

50-A, MDL. 10. ALL SHAFTS, ELEVATORS AND DUMBWAITERS SHALL BE AS PER

SECTION 51, MDL. 11. APARTMENT PEEPHOLES SHALL BE AS PER SECTION 51-A, MDL.

12. MIRRORS IN SELF-SERVICE ELEVATORS SHALL BE AS PER SECTION 51-B, MDL.

13. STAIRS SHALL BE AS PER SECTION 52. MDL

14. WAINSCOTING SHALL BE AS PER SECTION 55, MDL. 15. ENTRANCE BOLTS AND MAIL RECEPTACLES SHALL BE AS PER SECTION 57, MDL.

16. ALL INCOMBUSTIBLE MATERIALS SHALL BE AS PER SECTION 58, 17. PARAPETS AND GUARD RAILINGS SHALL BE AS PER SECTION 62,

18. SUB-CURB USES SHALL BE AS PER SECTION 63, MDL.

19. LIGHTING, GAS METERS, GAS AND OIL APPLIANCES SHALL BE AS PER SECTION 64, MDL 20. BOILER ROOMS SHALL BE AS PER SECTION 65, MDL

21. WATER SUPPLY SHALL BE AS PER SECTION 75, MDL. 22. WATER-CLOSET AND BATH ACCOMMODATIONS SHALL BE AS PER SECTION 76, MDL.

23. PLUMBING AND DRAINAGE SHALL BE AS PER SECTION 77, MDL.

24. REPAIRS SHALL BE MADE AS PER SECTION 78, MDL. 25. HEAT SHALL BE PROVIDED AS PER SECTION 79, MDL.

26. CLEANLINESS SHALL BE AS PER SECTION 80, MDL.

27. RECEPTACLES FOR WASTE MATTER SHALL BE AS PER SECTION 81, MDL. 28. PRIVACY SHALL BE AS PER SECTION 82, MDL.

29. JANITORIAL SERVICES SHALL BE AS PER SECTION 83, MDL. 30. CONSTRUCTION STANDARDS FOR THE CONTROL OF NOISE

SHALL BE AS ER SECTION 84, MDL. NYC SMOKE / CARBON MONOXIDE DETECTOR NOTES

CODE, MULTIPLE DWELLING LAW THE NEW YORK CITY BUILDING CODE THE NEW YORK CITY ELECTRICAL CODE AND NFPA 72. SMOKE DETECTORS AND CARBON MONOXIDE DETECTORS MAY BE COMBINED PROVIDING THE DEVICES COMPLY WITH THE PROVISIONS OF TITLE 28 OF THE ADMINISTRATIVE CODE OF THE CITY OF NEW YORK AND APPLICABLE RULES PROMULGATED

SMOKE/CARBON MONOXIDE DETECTORS OR DEVICES SHALL BE

INSTALLED IN ORDINANCE WITH THE HOUSING MAINTENANCE

THEREUNDER. EACH SMOKE/CARBON MONOXIDE DETECTOR SHALL BE INSTALLED IN ACCORDANCE WITH REFERENCE STANDARD UL 2034 AND UL 2075 OF THE NEW YORK CITY BUILDING CODE.

4. EACH SMOKE/CARBON MONOXIDE DETECTORS SHALL BE INSTALLED OUTSIDE OF EACH SLEEPING ROOM IN THE IMMEDIATE VICINITY OR WITHIN 15'-0" OF THE ENTRANCE TO A SLEEPING ROOM AND INSIDE EACH SLEEPING ROOM PER 908.7.1.1.1

EACH SMOKE/ CARBON MONOXIDE DETECTOR SHALL BE OF A TYPE THAT ALLOWS FOR READILY TESTING OF SUCH DEVICES. DUPLEX UNITS SHALL HAVE A DEVICES LOCATED ON EACH LEVEL

IF ONLY ONE MEANS OF EGRESS IS PROVIDED FROM EACH LEVEL.

SUFFOLK STREET KEY PLAN SCALE: NTS

> 10/14/16 | HPD REVISION 1 | 07/12/16 | HPD FILING SET | 08/14/15 | DOB FILING SET

381 Park Avenue South New York, N.Y. 10016 212-421-3712

The Stephen B. Jacobs Group, P.C.

Andi Pepper Interior Design

Interior Designers 381 Park Avenue South New York, N.Y. 10016 212-421-3712

C) 2015

Architects and Planners

McNamara-Salvia Consulting Engineers (Structural Engineering) 62 West 45th Street New York, N.Y. 10036 212-246-9800


Sideris Kefalas Engineers P.C. Consulting Engineers (MEP Engineering) 217-22 Northern Boulevard Bayside, N.Y. 11361

718-224-9091

Consulting Engineers (Support of Excavation) 512 7th Avenue New York, N.Y. 10018 646-484-3250


255 EAST HOUSTON ST. MANHATTAN, N.Y. 10002

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06 OF 40

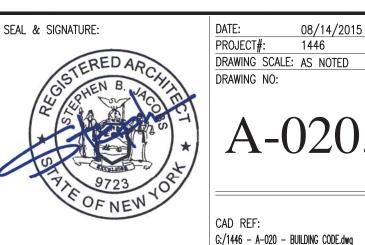
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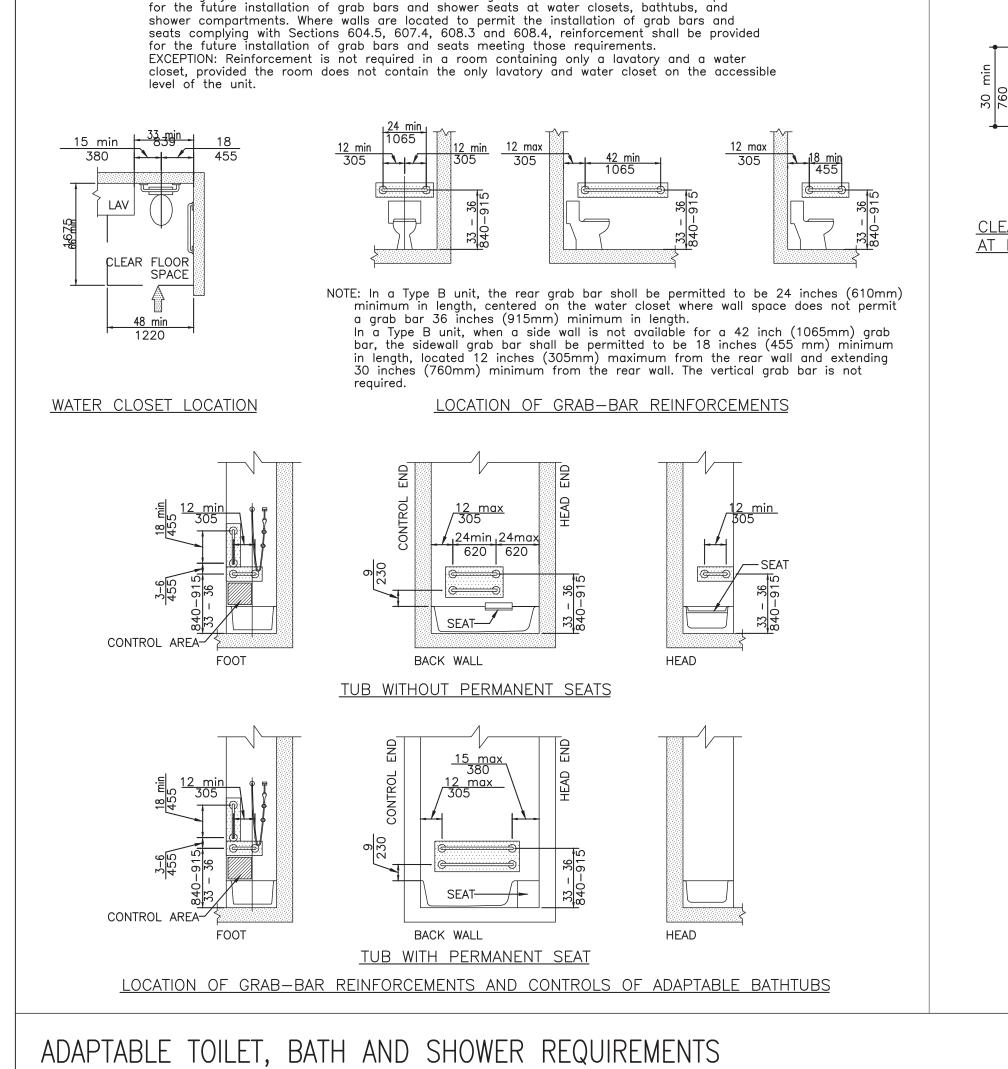


PUBLIC ENTRANCES


PUBLIC ENTRANCES: 100% ACCESSIBLE
PROVIDED: YES, MAIN ENTRANCE ON SUFFOLK STREET
(SEE 1ST FLOOR PLAN, DWG A-101)

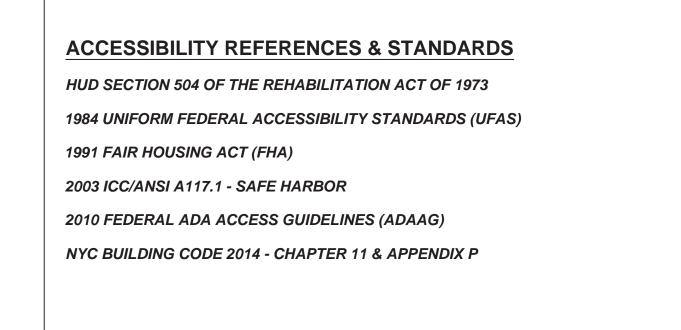
ACT ACOUSTICAL TILE FHC FIRE HOSE CABINET MO MASONRY OPENING SO SQUARE AL ALUMINUM FIN FINISH(ED) MRB MABBLE SS STAINLESS STEEL ALTERNATE FLR FLOOR(ING) MS. MABBLE SS STAINLESS STEEL AFF ABOVE FINISHED FLOOR FPA FIRE ALAMI INTERCOM STATION MTD. MOUNTED STC SOUND TRANSMISSION CONTROL A.S. ALUMINUM SADDLE FRP FISE FIRE PROOF SELF-CLOSING MTL METAL B.C. BRICK COURSE(S) FS FIRE STANDPIPE NIC NOT IN CONTRACT T.C. TOP OF CURB B.D. BOARD FT FOOT (FEET) NOM NOMINAL TX TOILET EXHAUST BF BOLLER FLUE GA GAGE, GAUGE NR NOT REQUIRED TEL TELEPHONE BOTTOM ULL UNITED LAB FIRE-RATED DESIGNATION NTS NOT TO SCALE THE THE THEORY AND	LEGEND
CT CERAMIC TILE HR HOUR(S) DIAM DIAMETER H.R. HANDRAIL RC RUBBISH ROOM VCJ VINYL COMPOSITION FLOOR TILE DIAM DIAMETER H.R. HANDRAIL RC RUBBISH ROOM VCJ VINYL COMPOSITION FLOOR TILE DIAM DIAMETER H.R. HANDRAIL RC RUBBISH ROOM VCJ VINYL COMPOSITION FLOOR TILE DIAM DIAMETER H.R. HANDRAIL RC RUBBISH ROOM VCJ VINYL COMPOSITION FLOOR TILE DR DOOR HVAC HEATING/VENTILATING/AIR CONDITIONING RD ROOF DRAIN VWC VINYL WALL COVERING DTL DETAIL IN INCERIOR REV REVISION(S), REVISED WC WATER CLOSET DWG DRAWING INT INTERIOR REV REVISION(S), REVISED WC WASHER/DRYER EL ELEVATION INV INVERT RF RESTAURANT FLUE WD WOOD EQ EQUAL JNT JOINT RH RADIANT HEATING PANEL WMO WASHING MACHINE OUTLET BOX EXG EXISTING KD KNOCK-DOWN RM ROOM WR WATER RESISTANT EXT EXTERIOR LC. LINEN CLOSET SD SMOKE DETECTOR EAT EXTERIOR LC. LINEN CLOSET SD SMOKE DETECTOR FAL FRESH AIR INTAKE LP LOW POINT SECT SECTION FO. FIRE CODE MAX MAXIMUM SF SQUARE FEET FD FLOOR DRAIN MRS. MASONRY SIM SIMILAR F.E. FIRE EXTINGUISHER MIN MINIMUM SPKLR SPRINKLER (HEAD)	STEEL




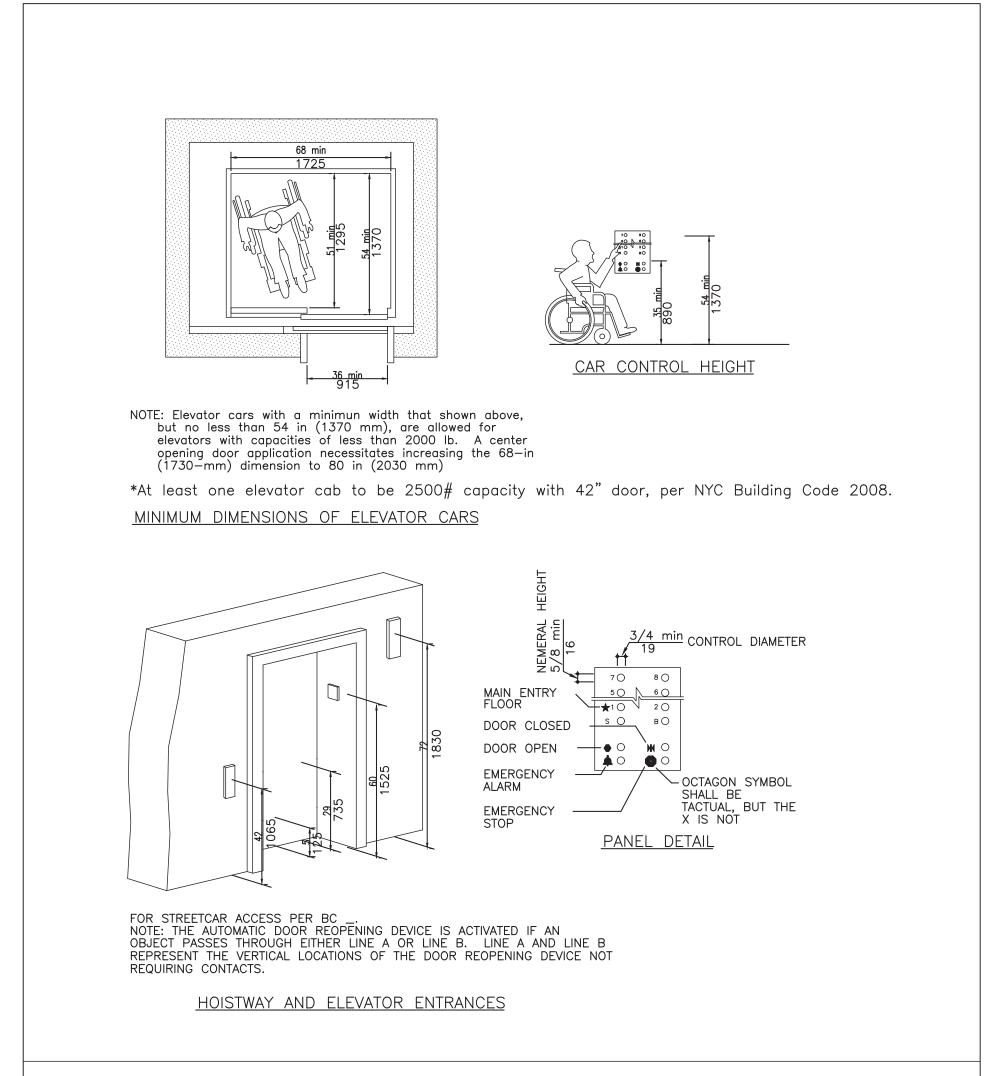



NOTE: The lightly shaded area are reinforced to receive grab bars. Reinforcement shall be provided

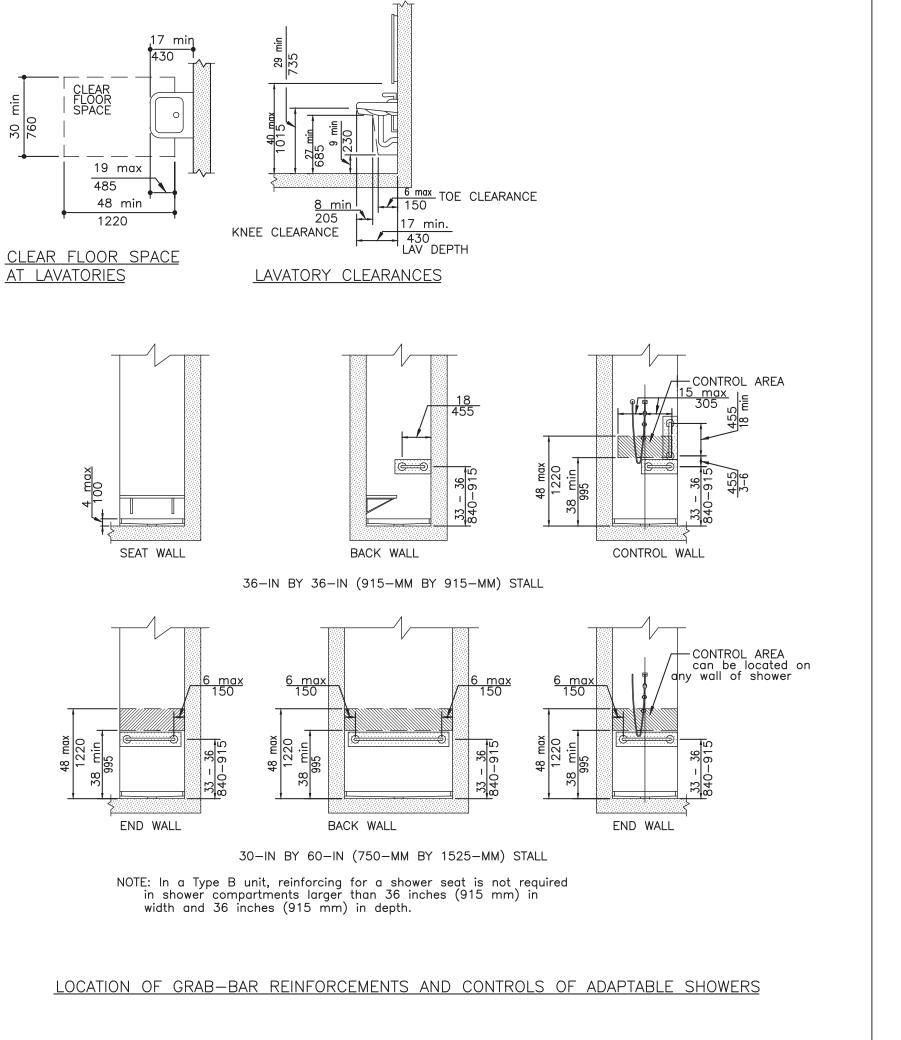


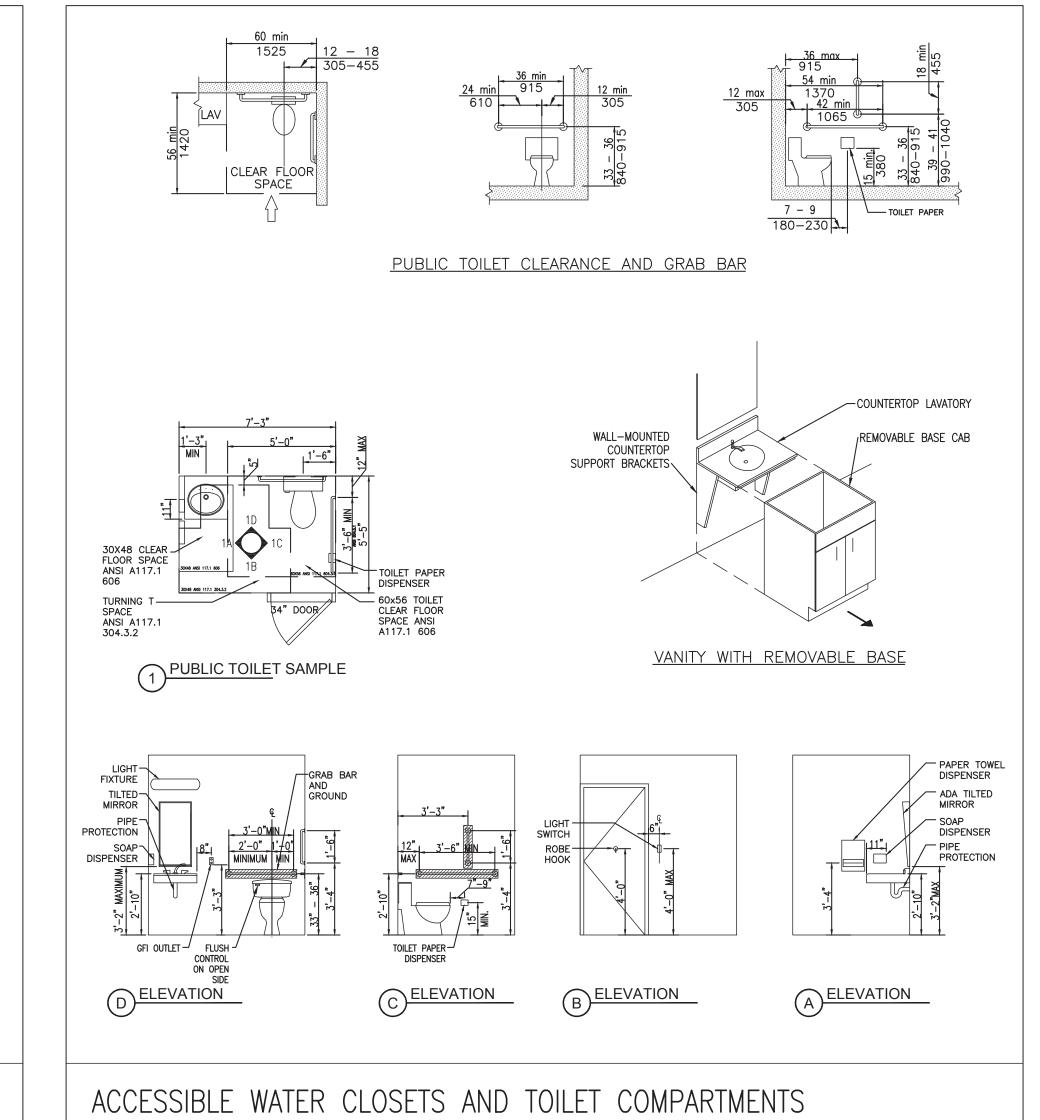


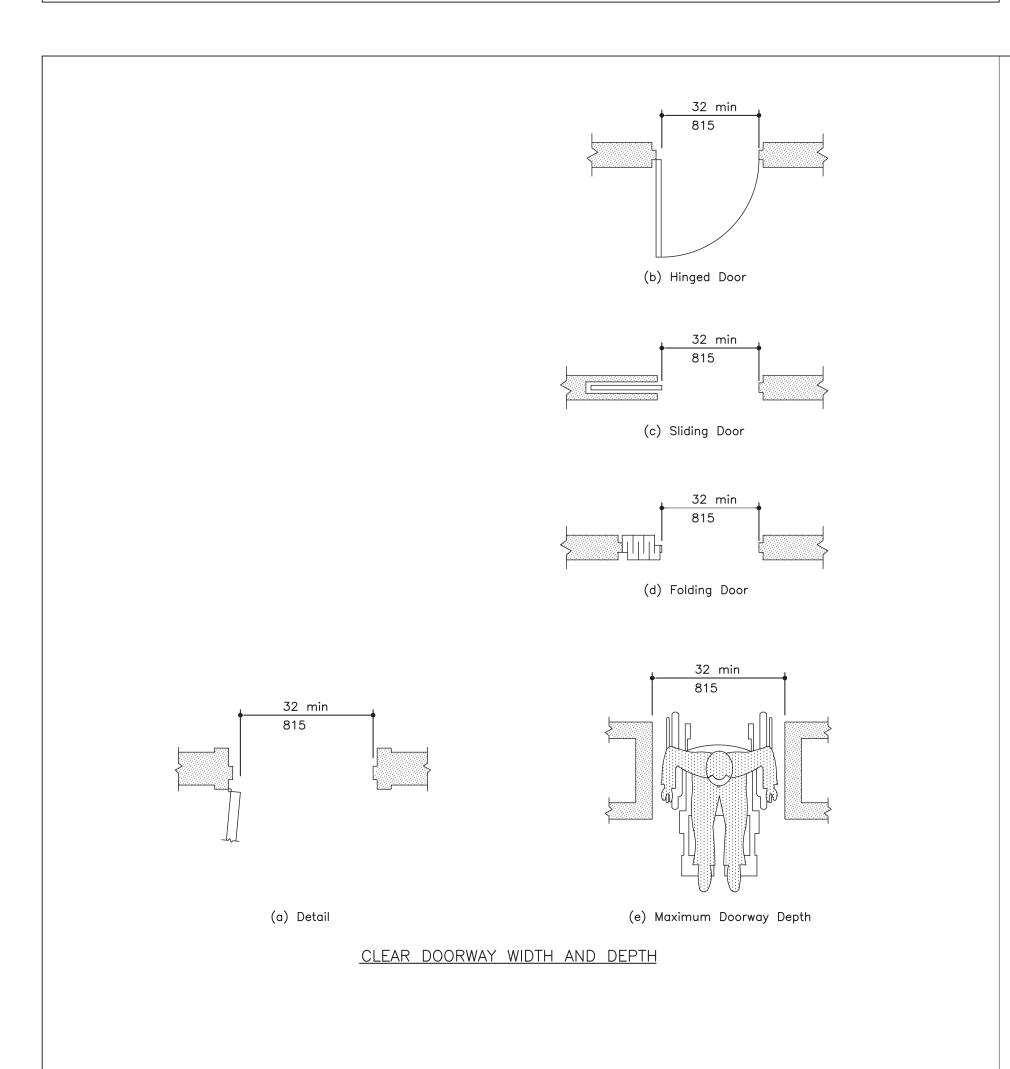


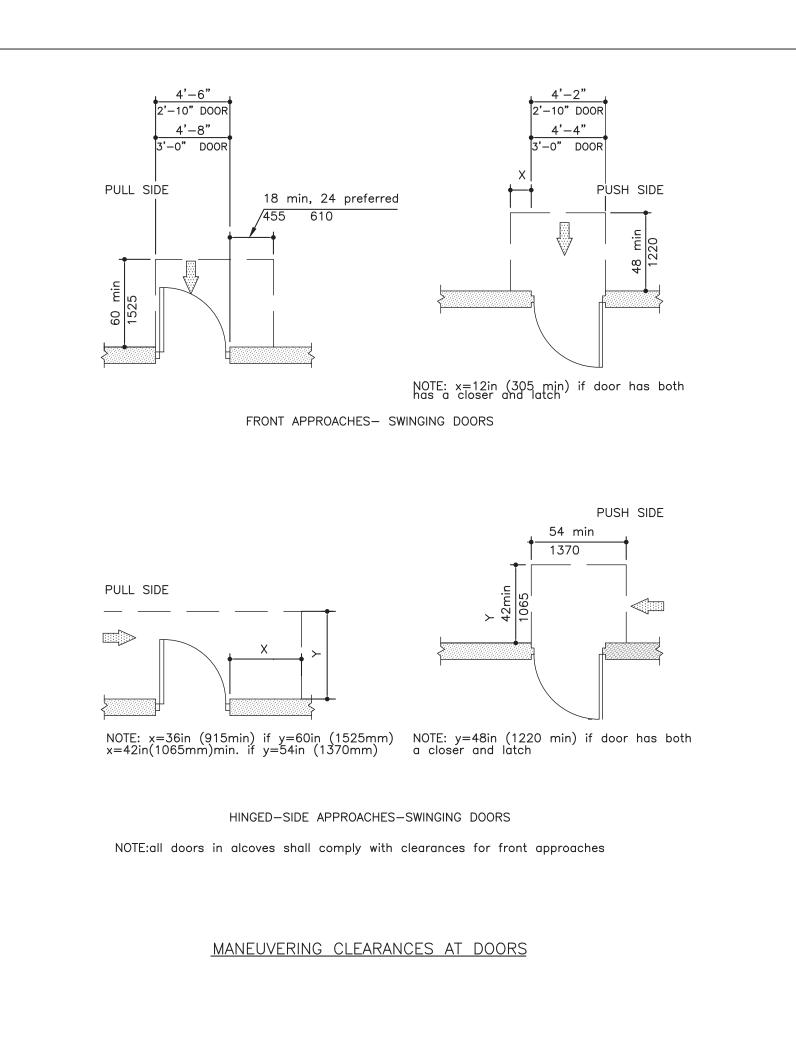

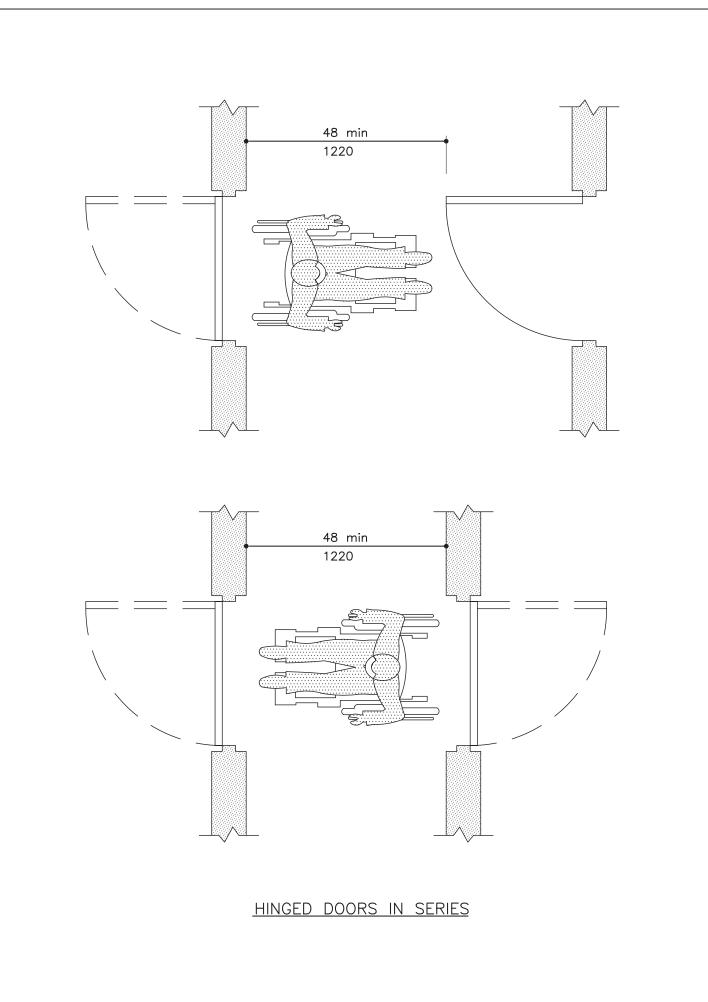

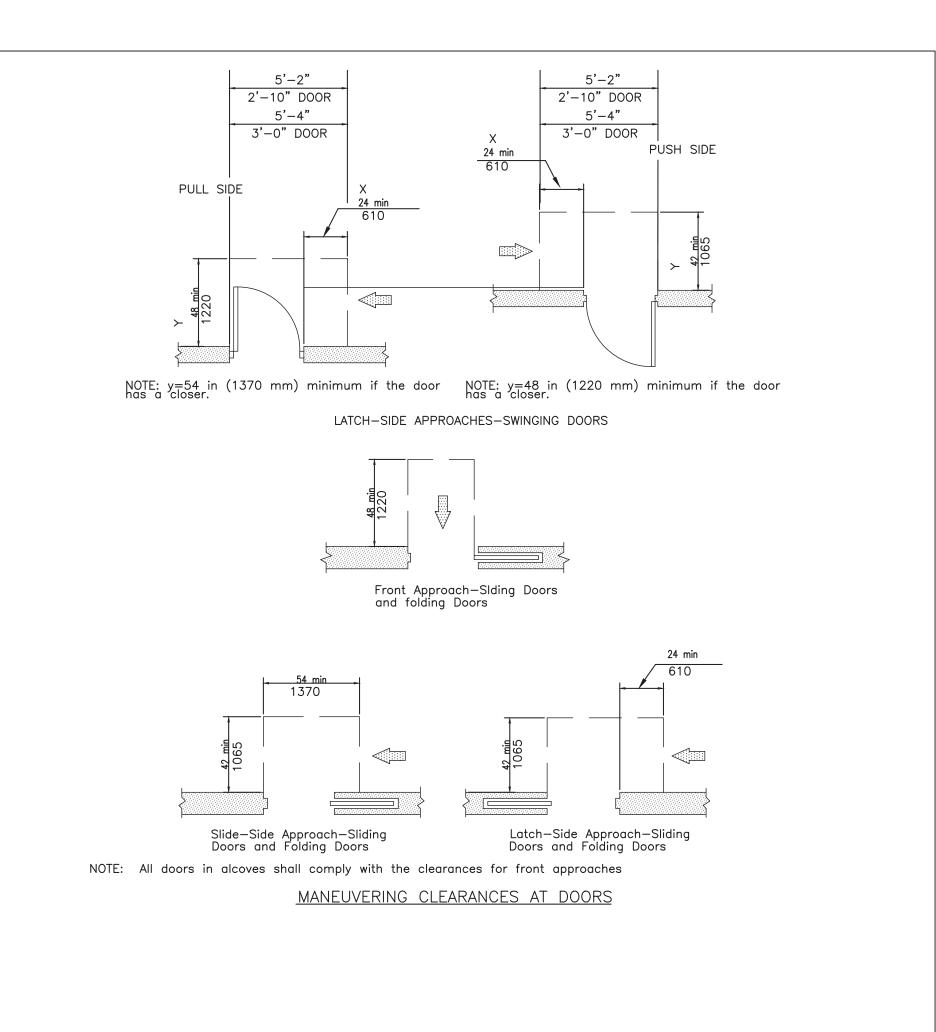

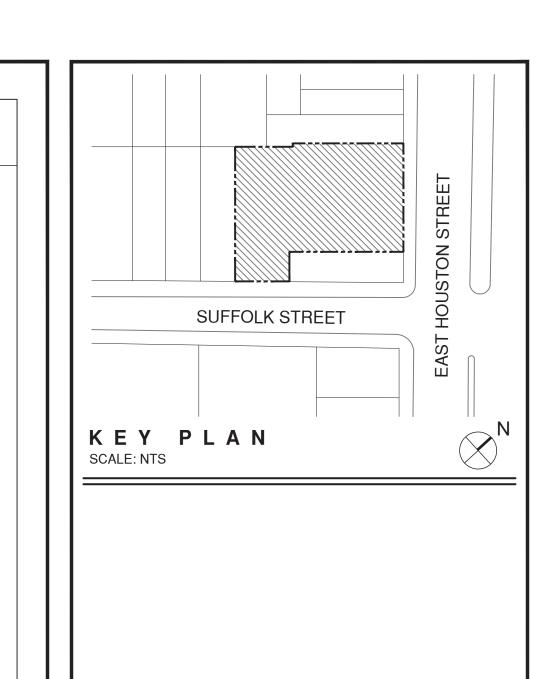


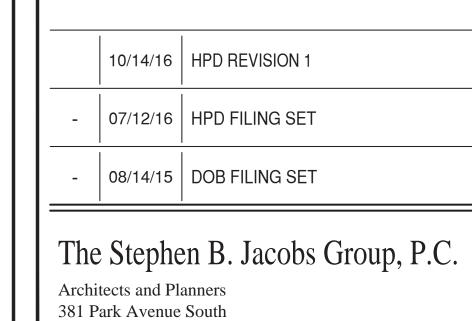


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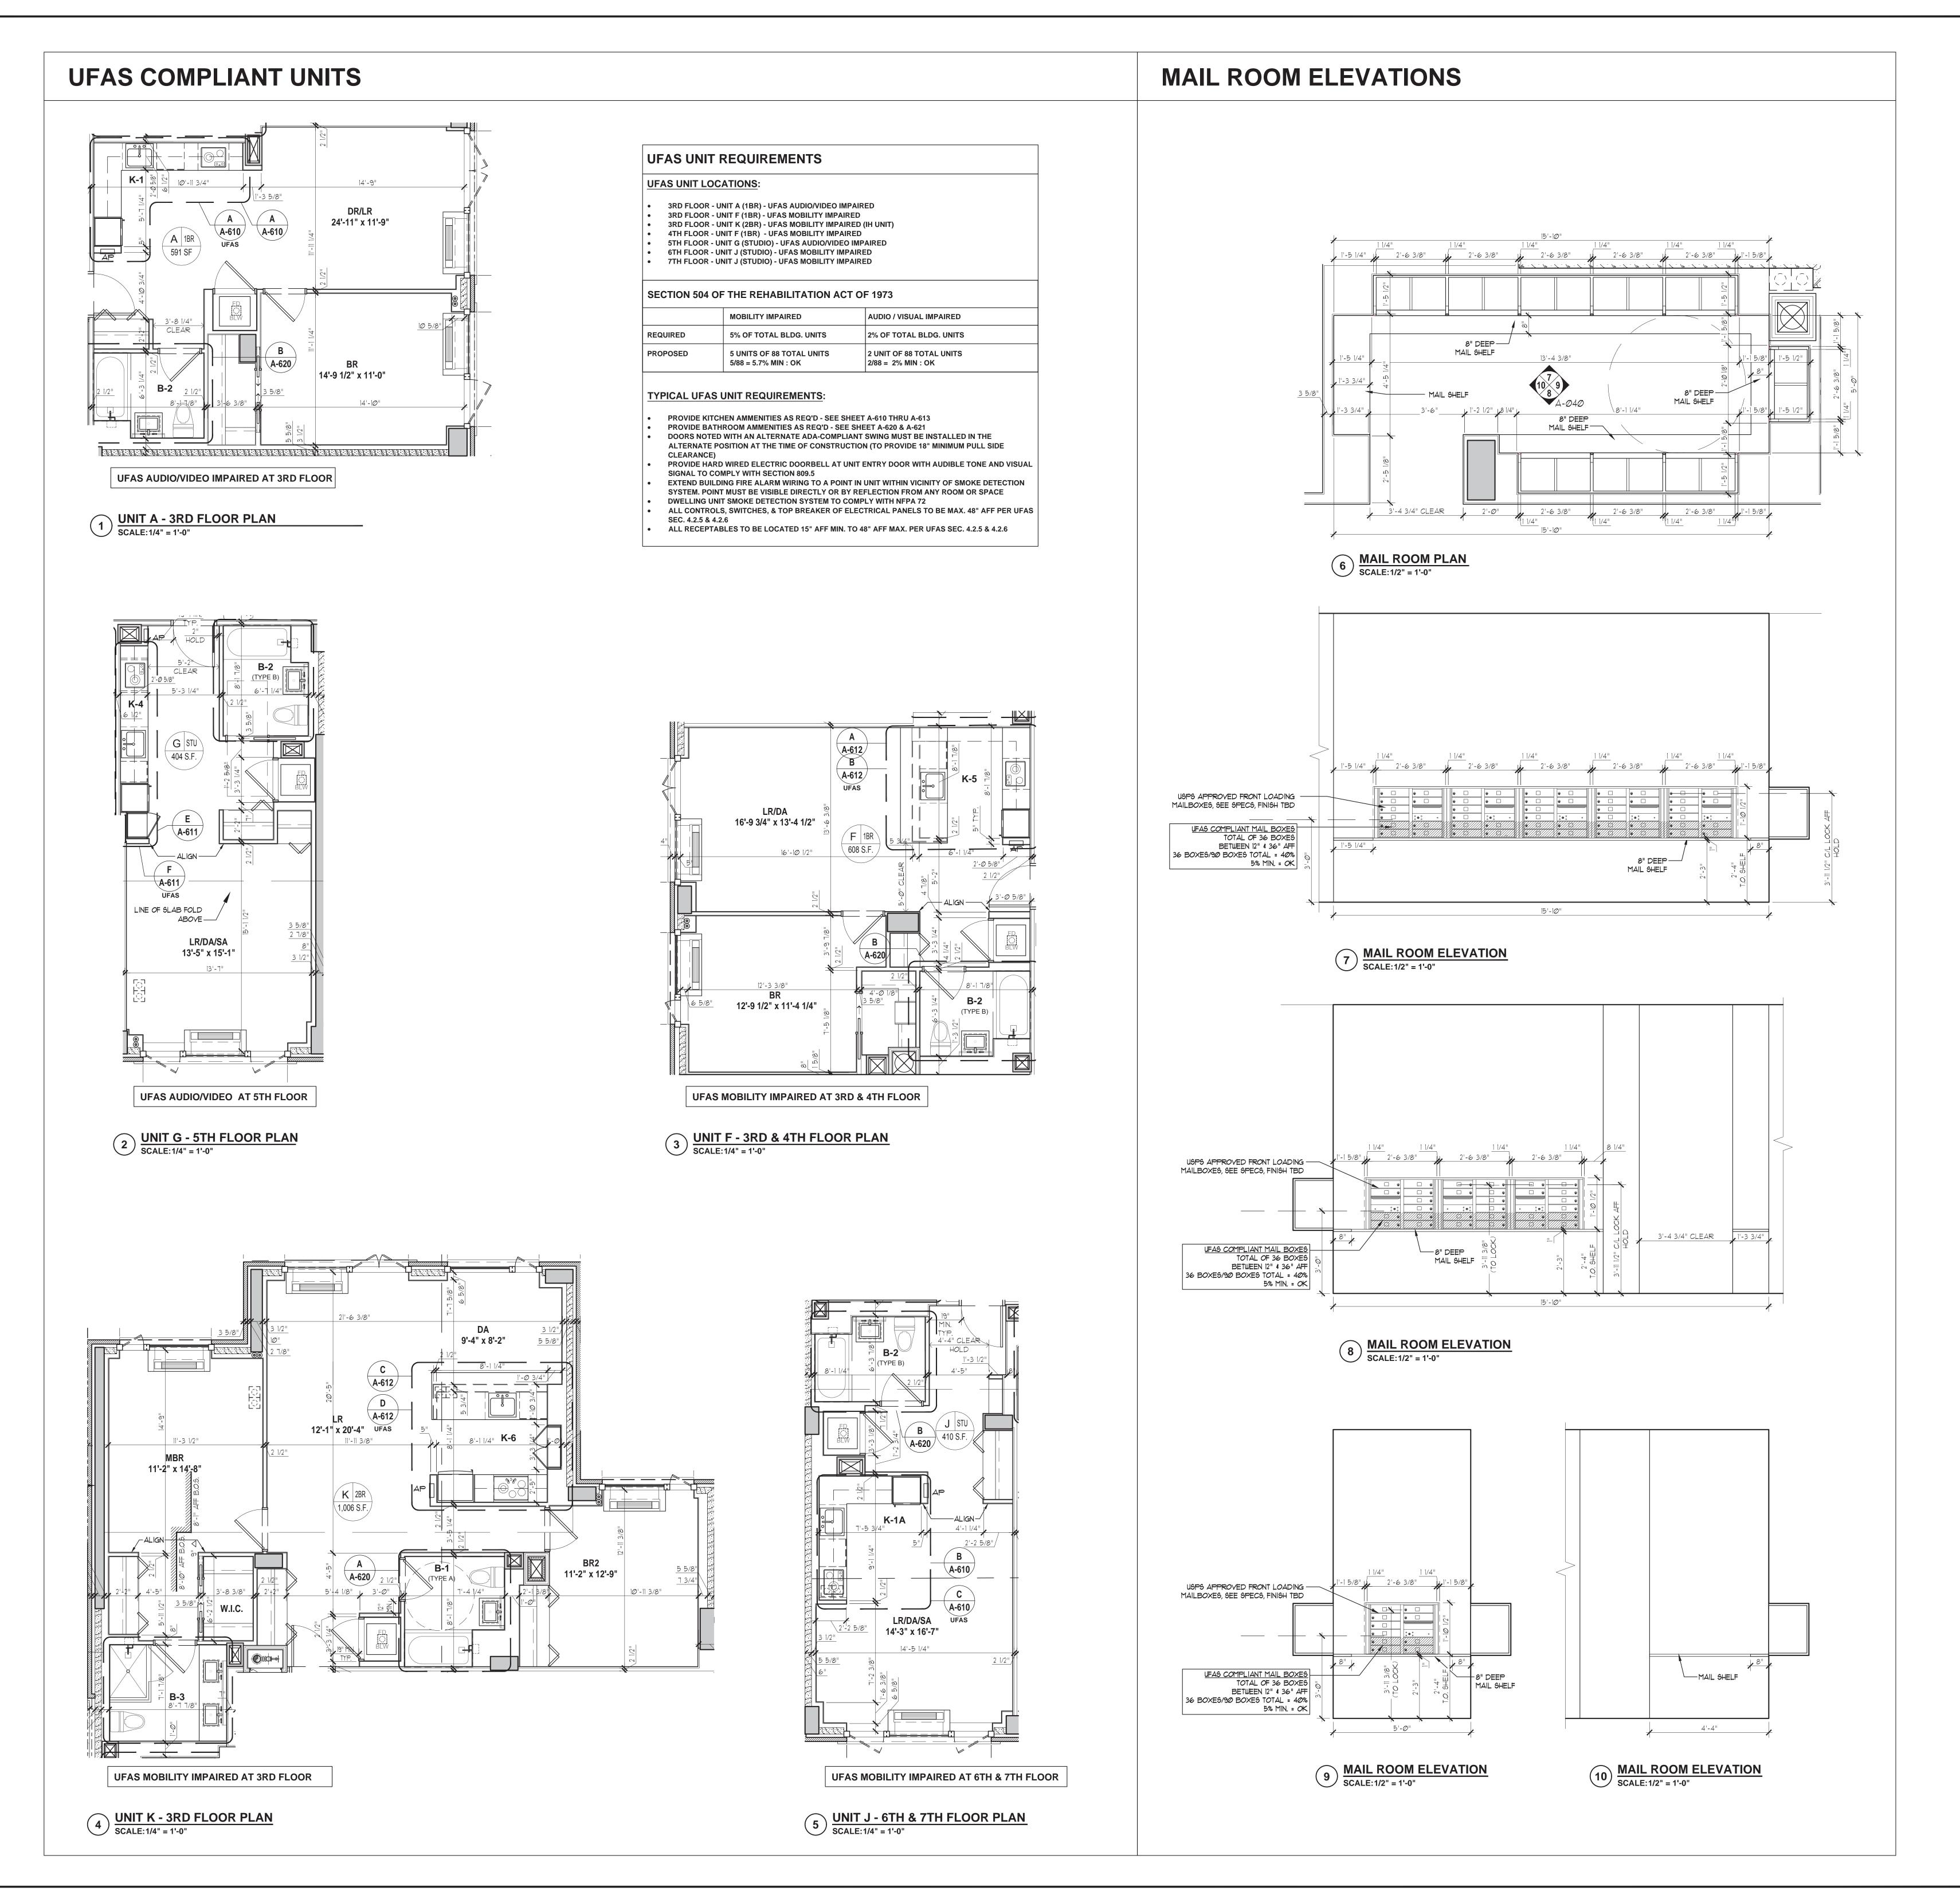
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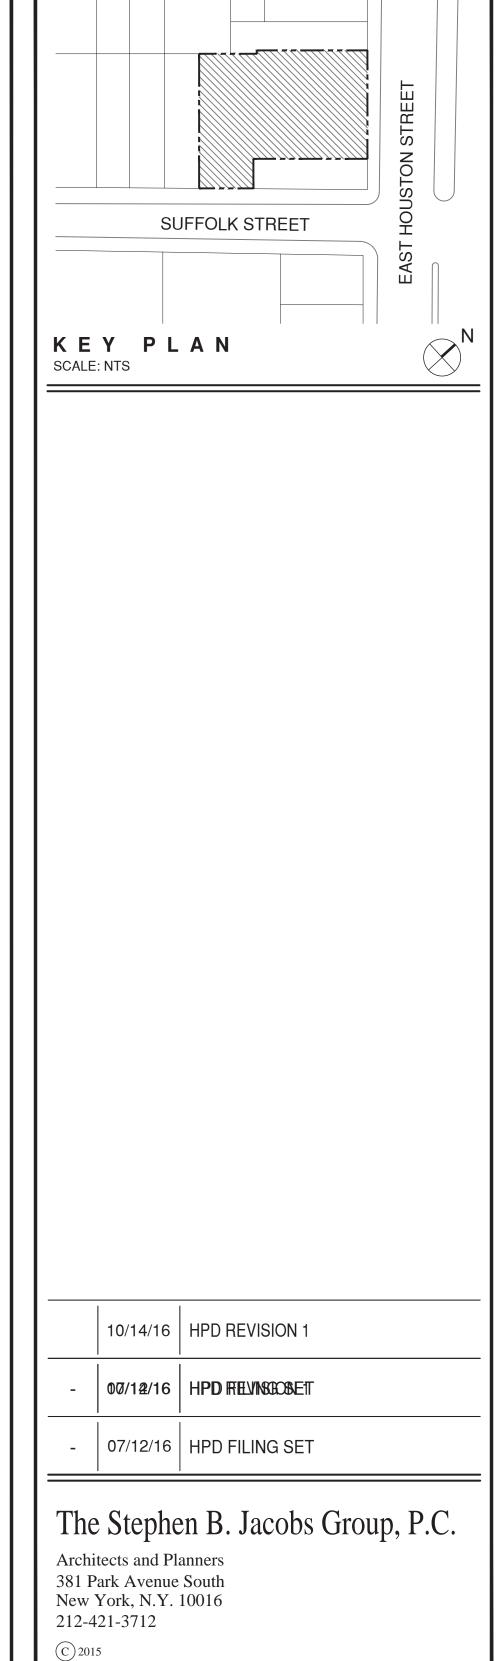
255 EAST HOUSTON ST. MANHATTAN, N.Y. 10002

Drawing Title:
HANDICAP
REQUIREMENTS

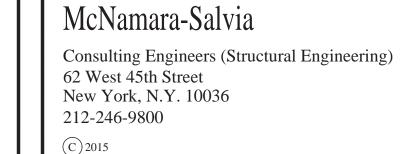

ACCESSIBLE ELEVATOR REQUIREMENTS

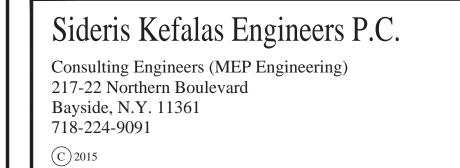



Andi Pepper Interior Design

Interior Designers
381 Park Avenue South
New York, N.Y. 10016

212-421-3712

McNamara-Salvia

Consulting Engineers (Structural Engineering)
62 West 45th Street
New York, N.Y. 10036
212-246-9800

Sideris Kefalas Engineers P.C.

Consulting Engineers (MEP Engineering)
217-22 Northern Boulevard

Payrida N.V. 11361

217-22 Northern Bou Bayside, N.Y. 11361 718-224-9091

R A Consultants LLC

Consulting Engineers (Support of Excavation) 512 7th Avenue New York, N.Y. 10018 646-484-3250


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255 EAST HOUSTON ST. MANHATTAN, N.Y. 10002


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UFAS MOBILITY & A/V IMPAIRED

ADAPTABLE UNIT PLANS





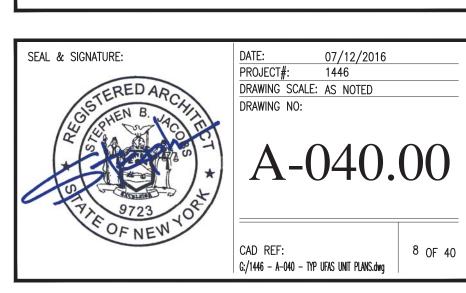

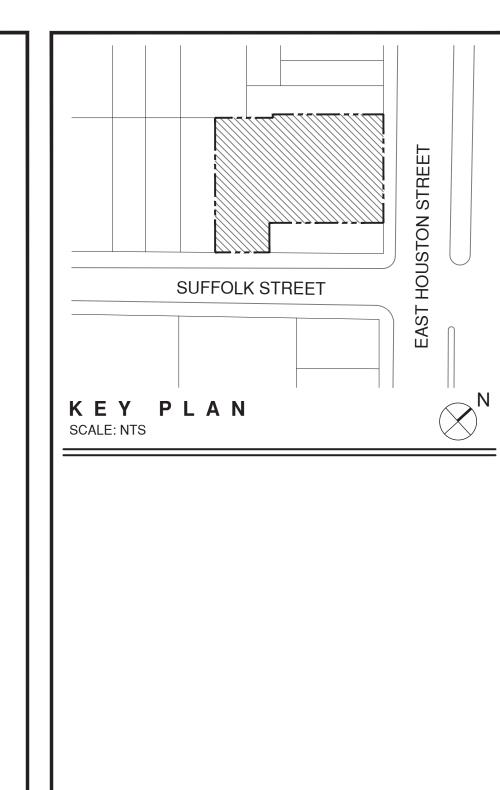10/14/16 | HPD REVISION 1 00/12/16 HPD FELVINGCOSET 07/12/16 HPD FILING SET

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R A Consultants LLC


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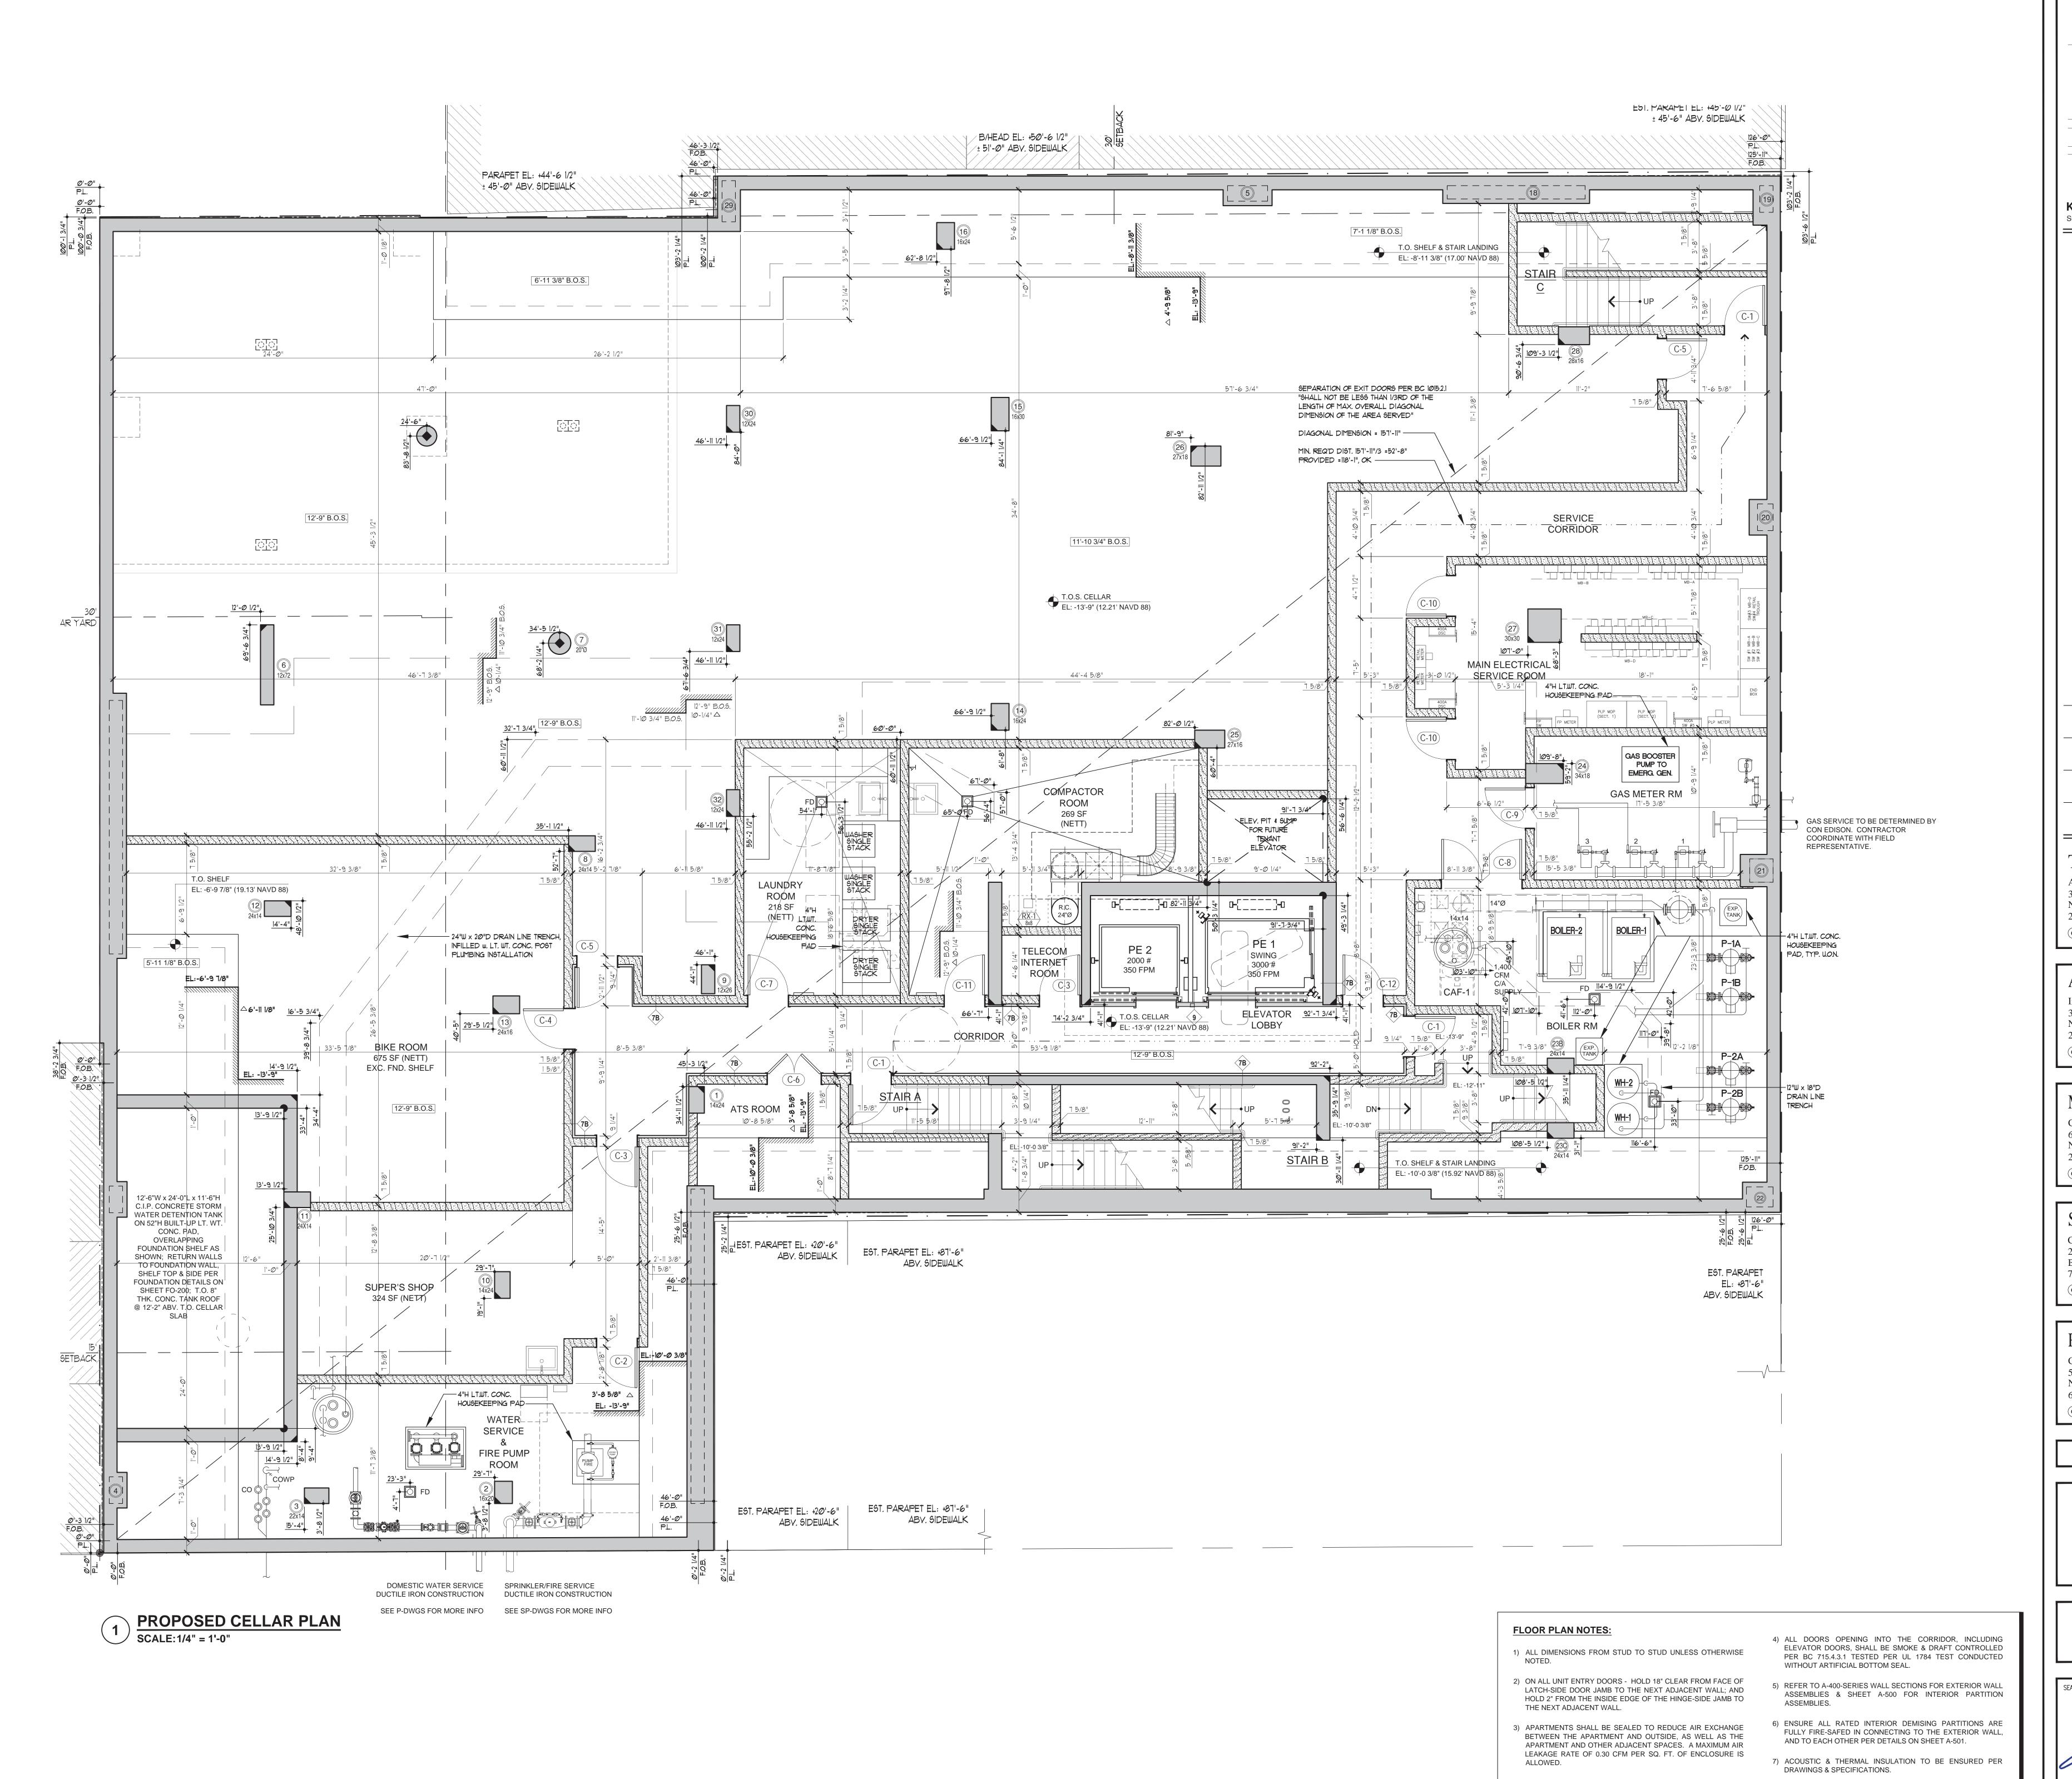
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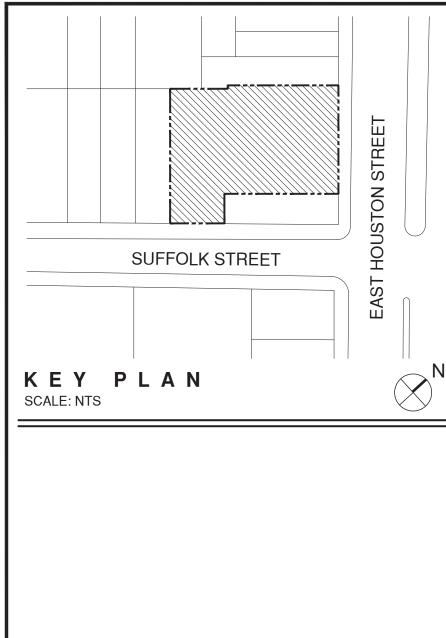
255 EAST HOUSTON ST. MANHATTAN, N.Y. 10002

9 OF 40

INCLUSIONARY HOUSING AFFORDABLE APT. PLANS





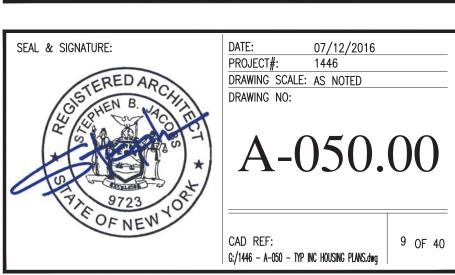

10/14/16 | HPD REVISION 1 07/12/16 | HPD FILING SET

- 06/29/16 FOUNDATION BID SET
- 08/14/15 DOB FILING SET

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Bayside, N.Y. 11361
718-224-9091

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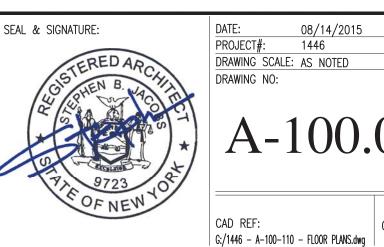
Consulting Engineers (Support of Excavation) 512 7th Avenue New York, N.Y. 10018 646-484-3250


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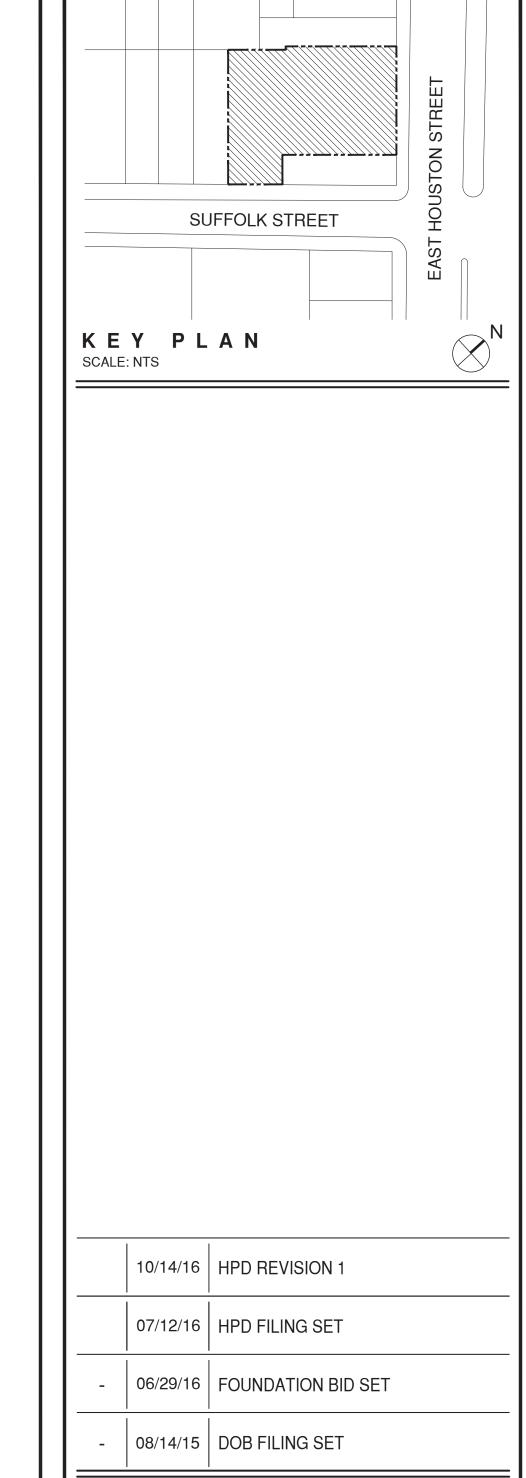
255 EAST HOUSTON ST. MANHATTAN, N.Y. 10002

Drawing Title:

CELLAR FLOOR PLAN





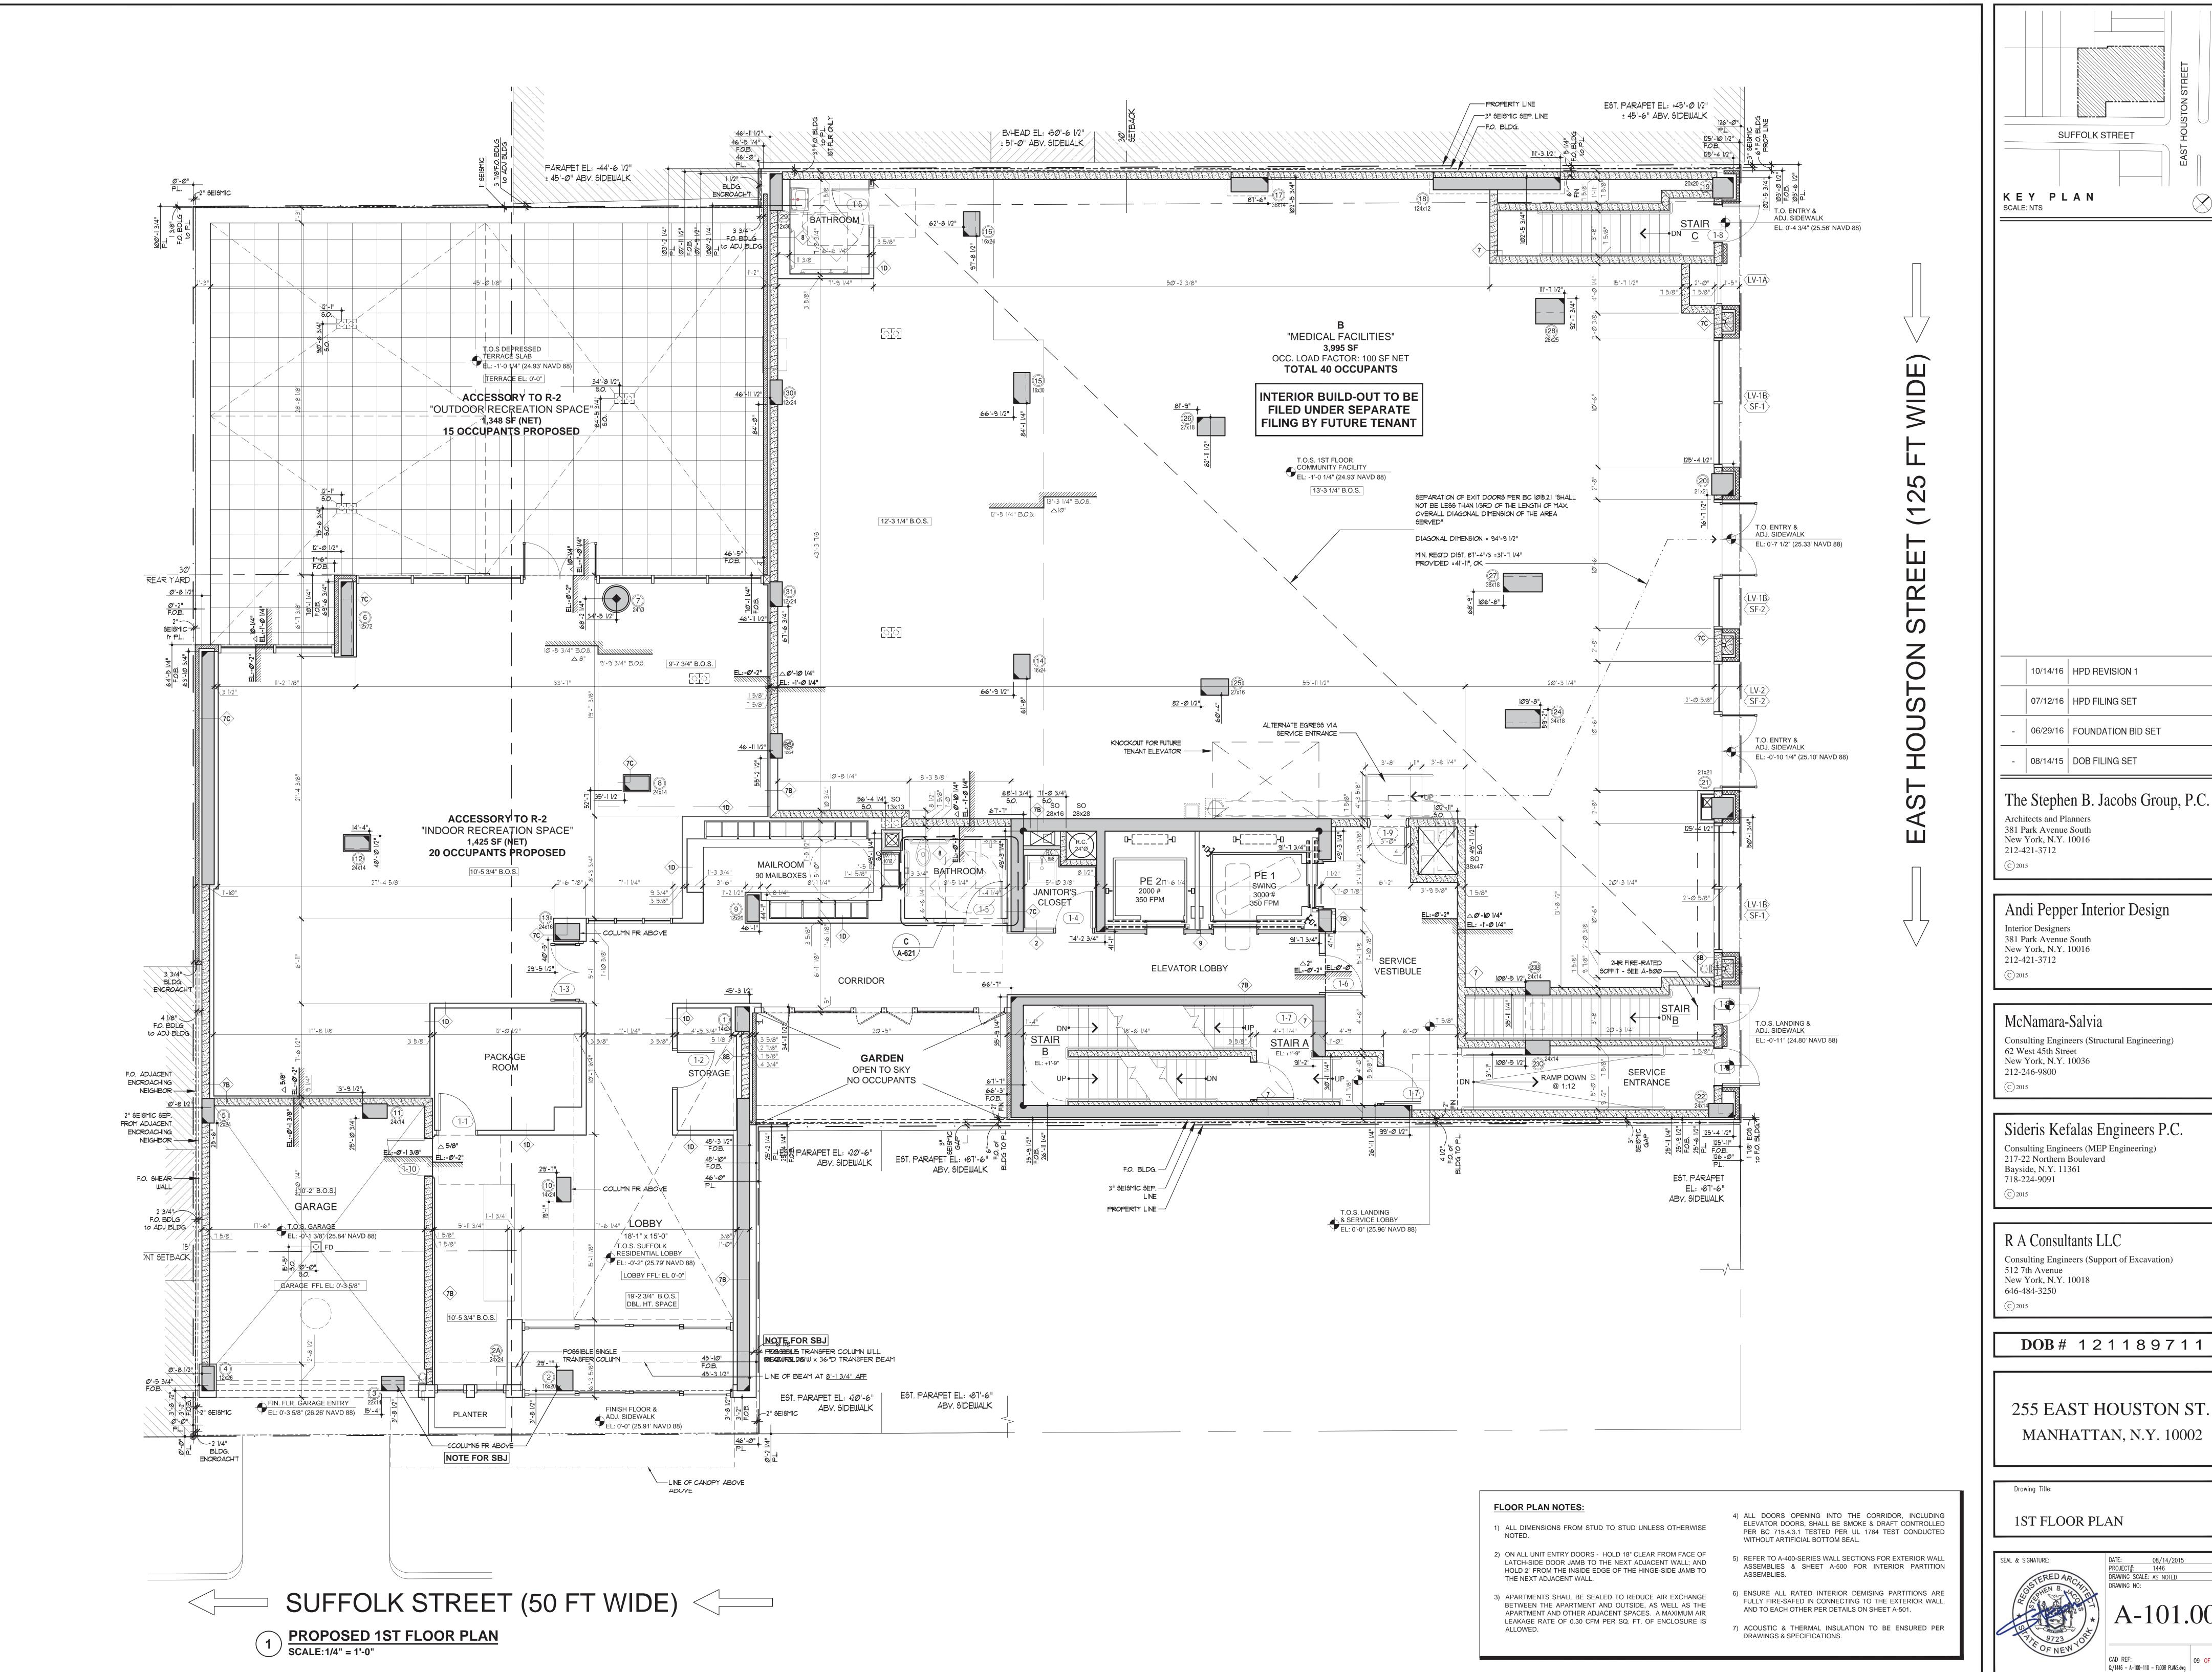

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Sideris Kefalas Engineers P.C. Consulting Engineers (MEP Engineering) 217-22 Northern Boulevard

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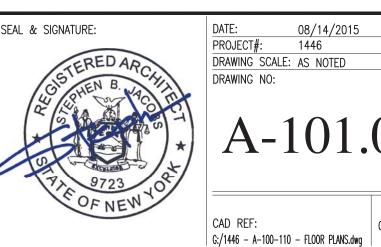
Consulting Engineers (Support of Excavation) 512 7th Avenue New York, N.Y. 10018 646-484-3250


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255 EAST HOUSTON ST. MANHATTAN, N.Y. 10002

Drawing Title:

1ST FLOOR PLAN



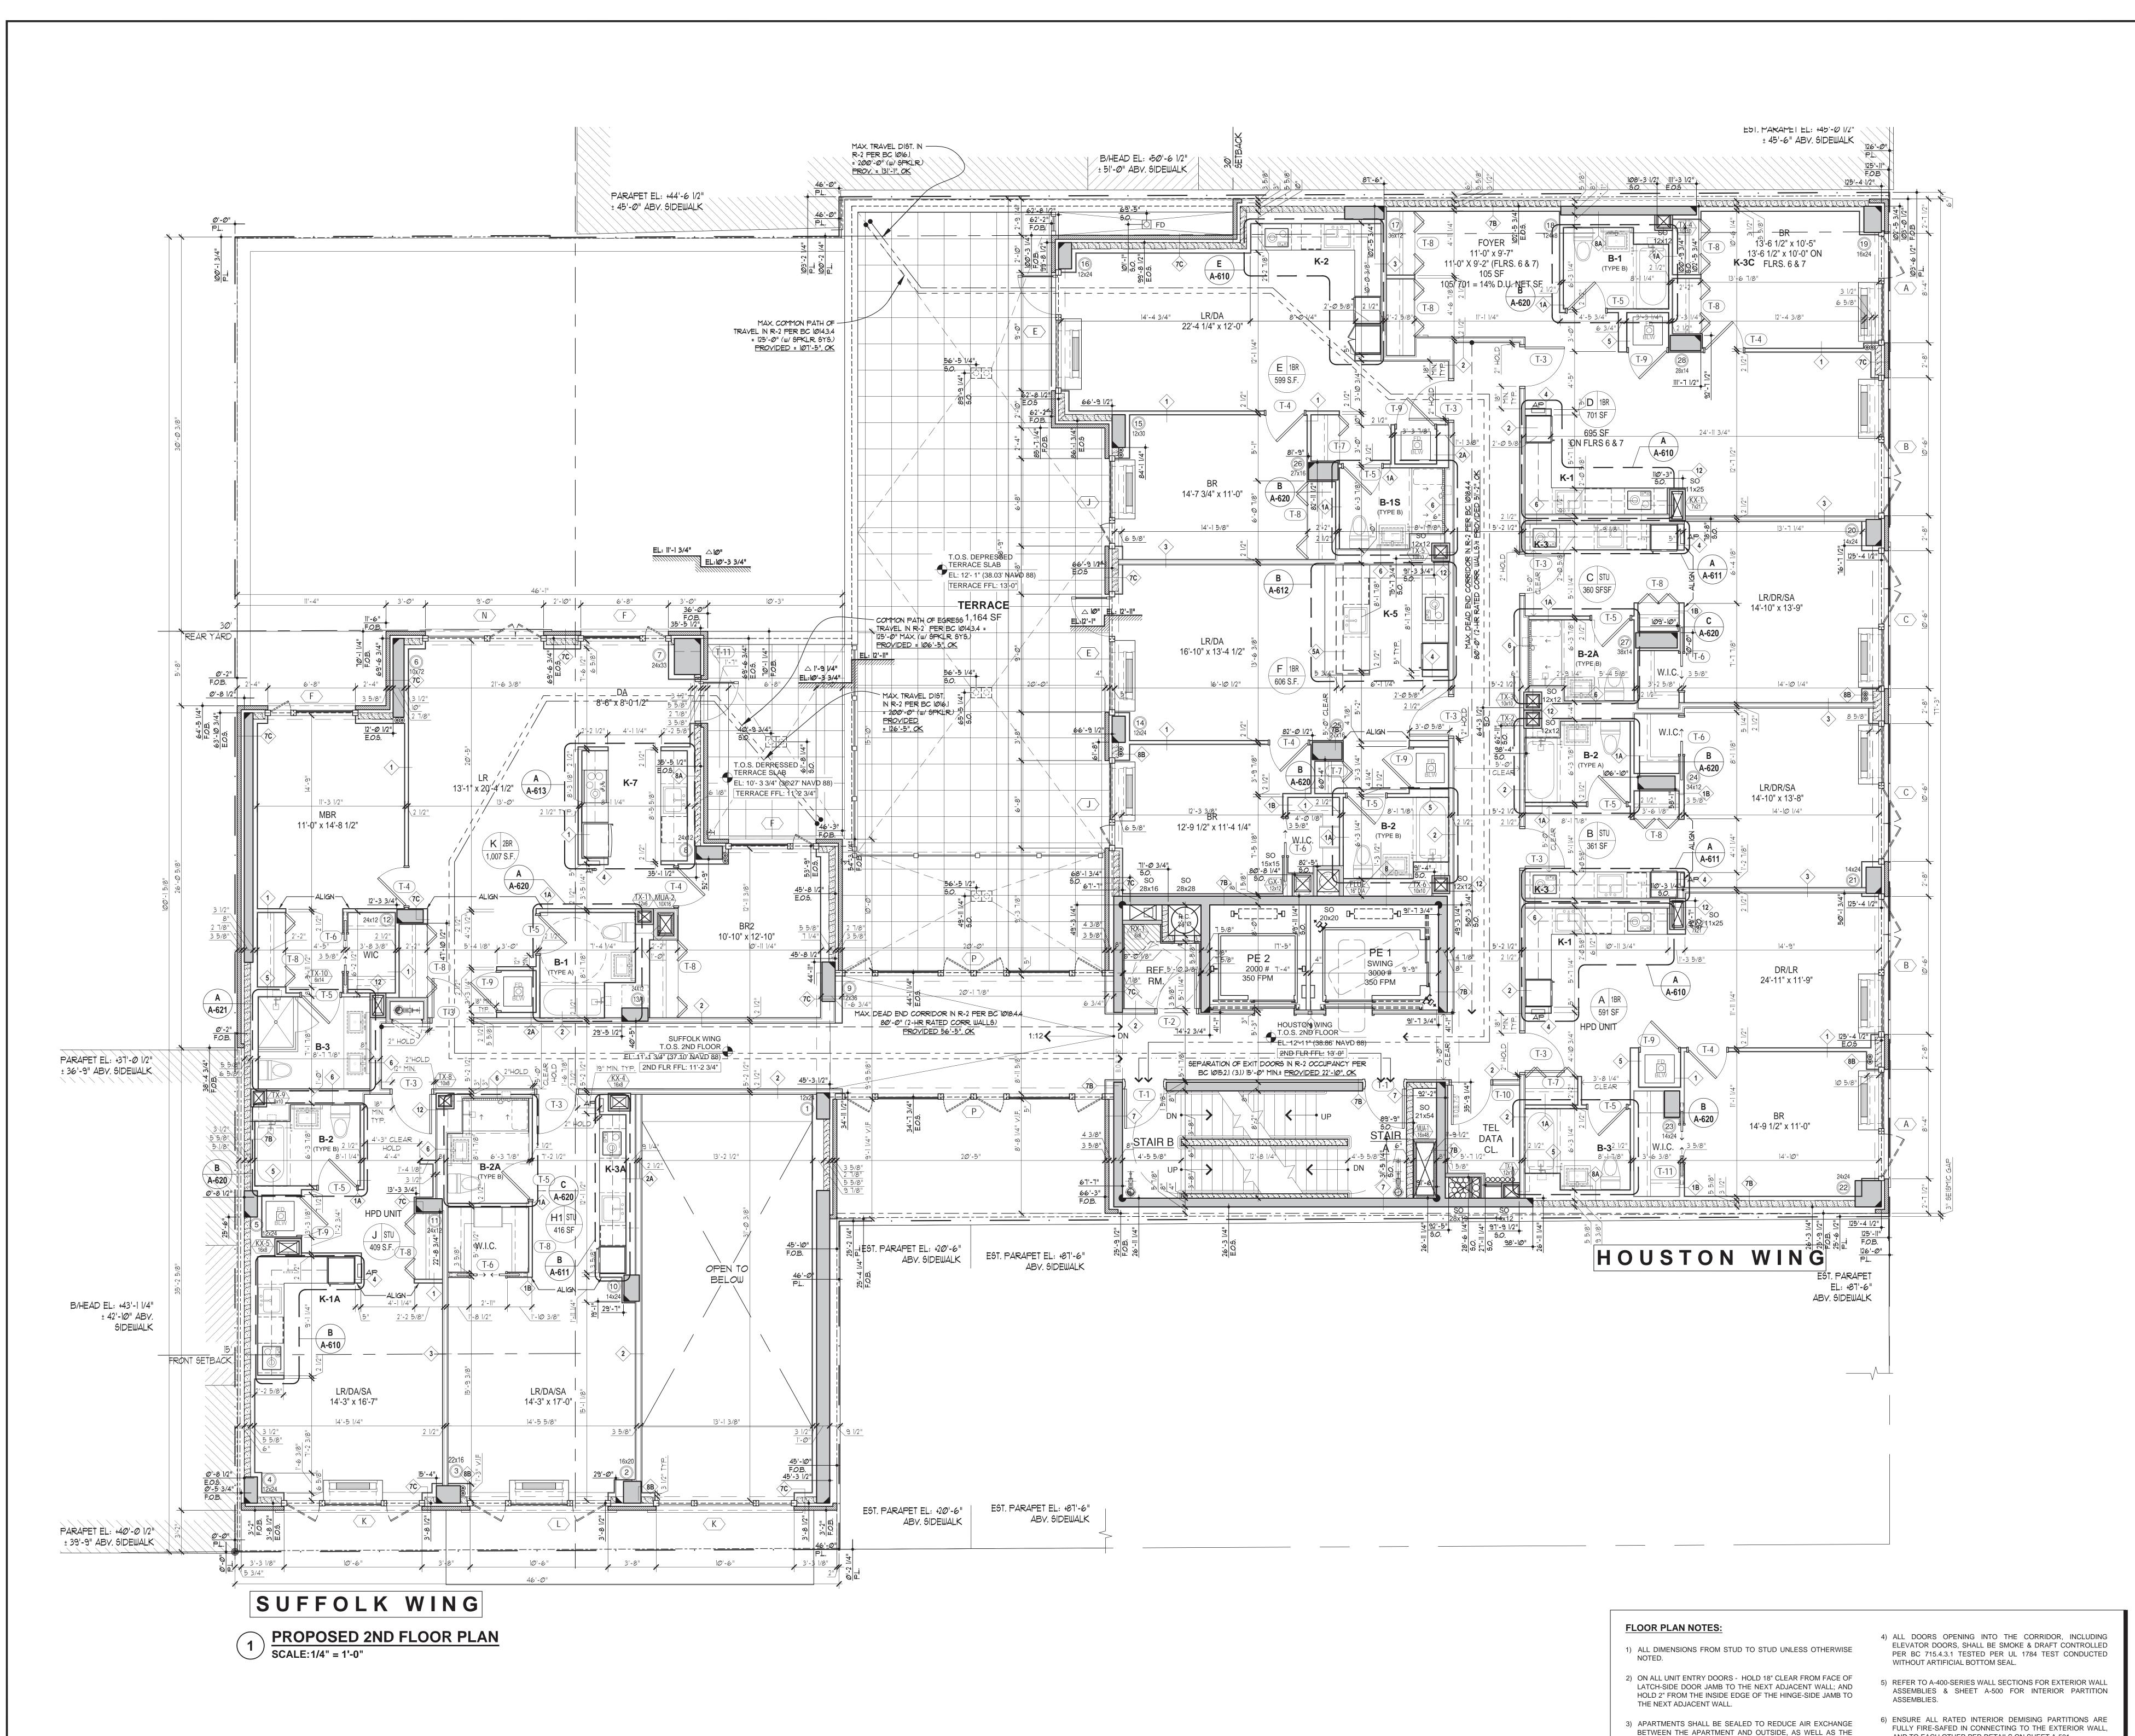

SUFFOLK STREET KEY PLAN SCALE: NTS 10/14/16 | HPD REVISION 1 07/12/16 | HPD FILING SET 08/14/15 DOB FILING SET The Stephen B. Jacobs Group, P.C. Architects and Planners 381 Park Avenue South New York, N.Y. 10016

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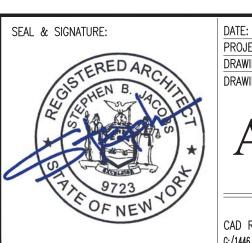
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DRAWINGS & SPECIFICATIONS.

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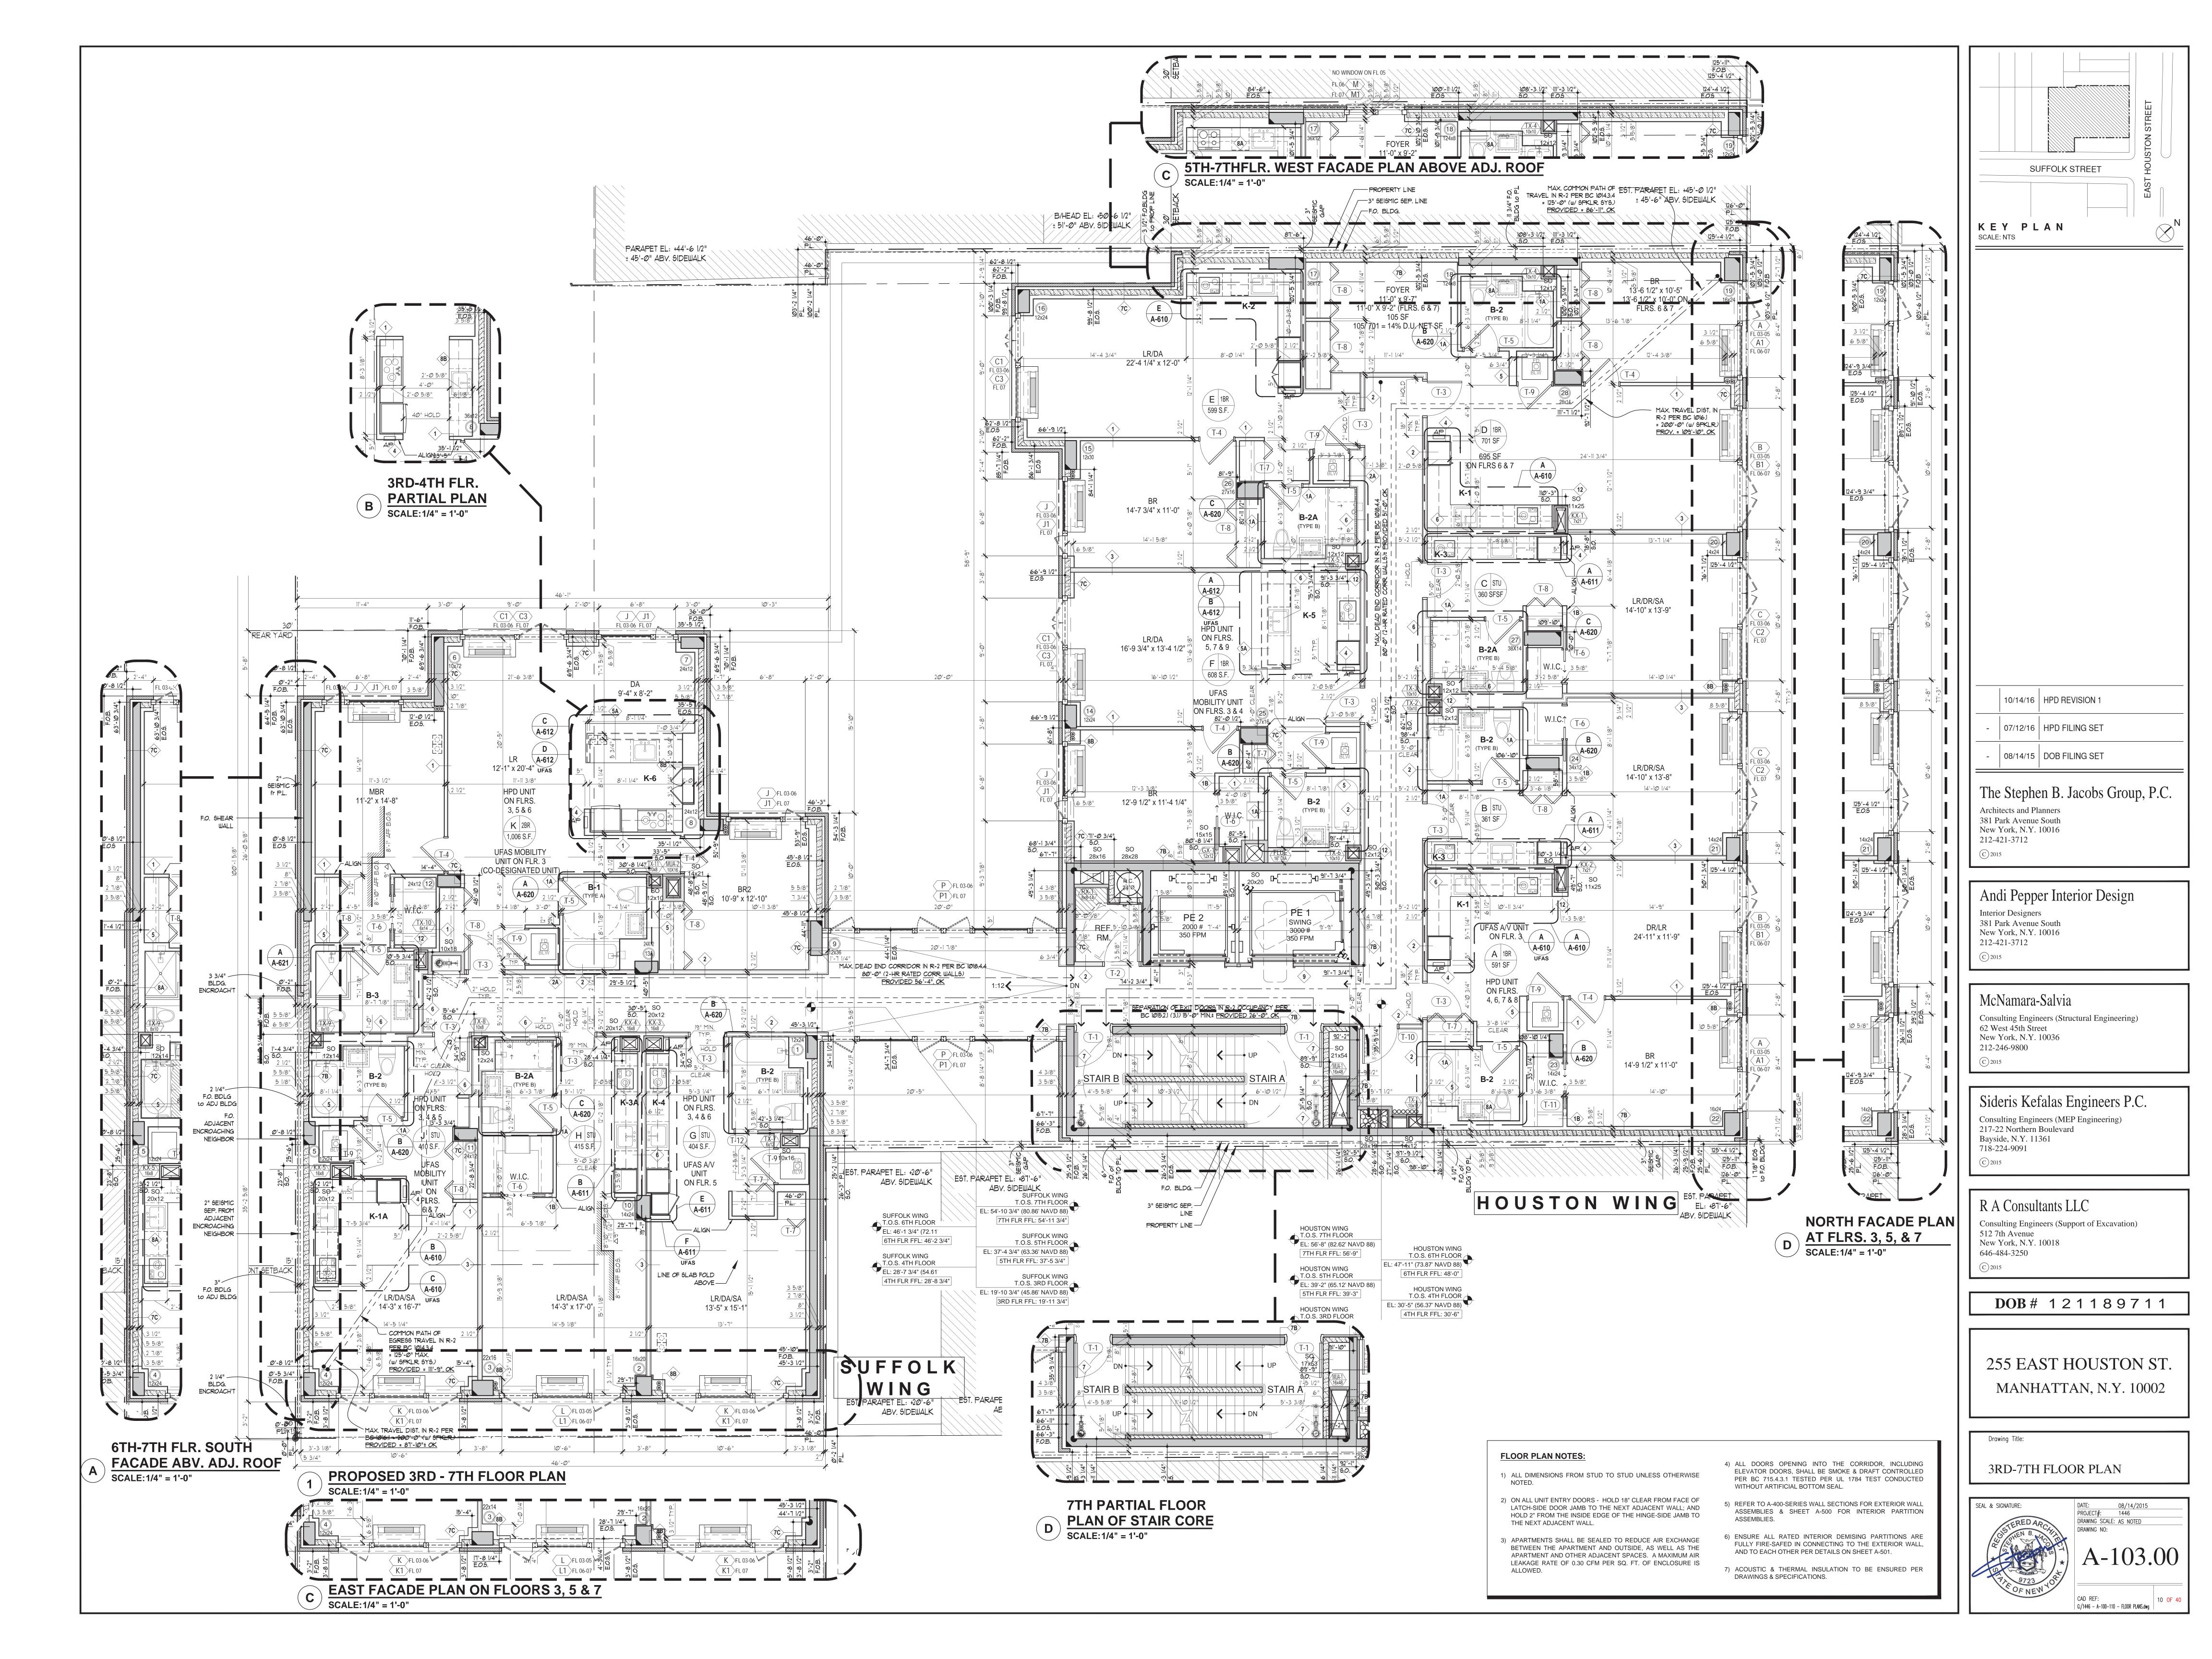
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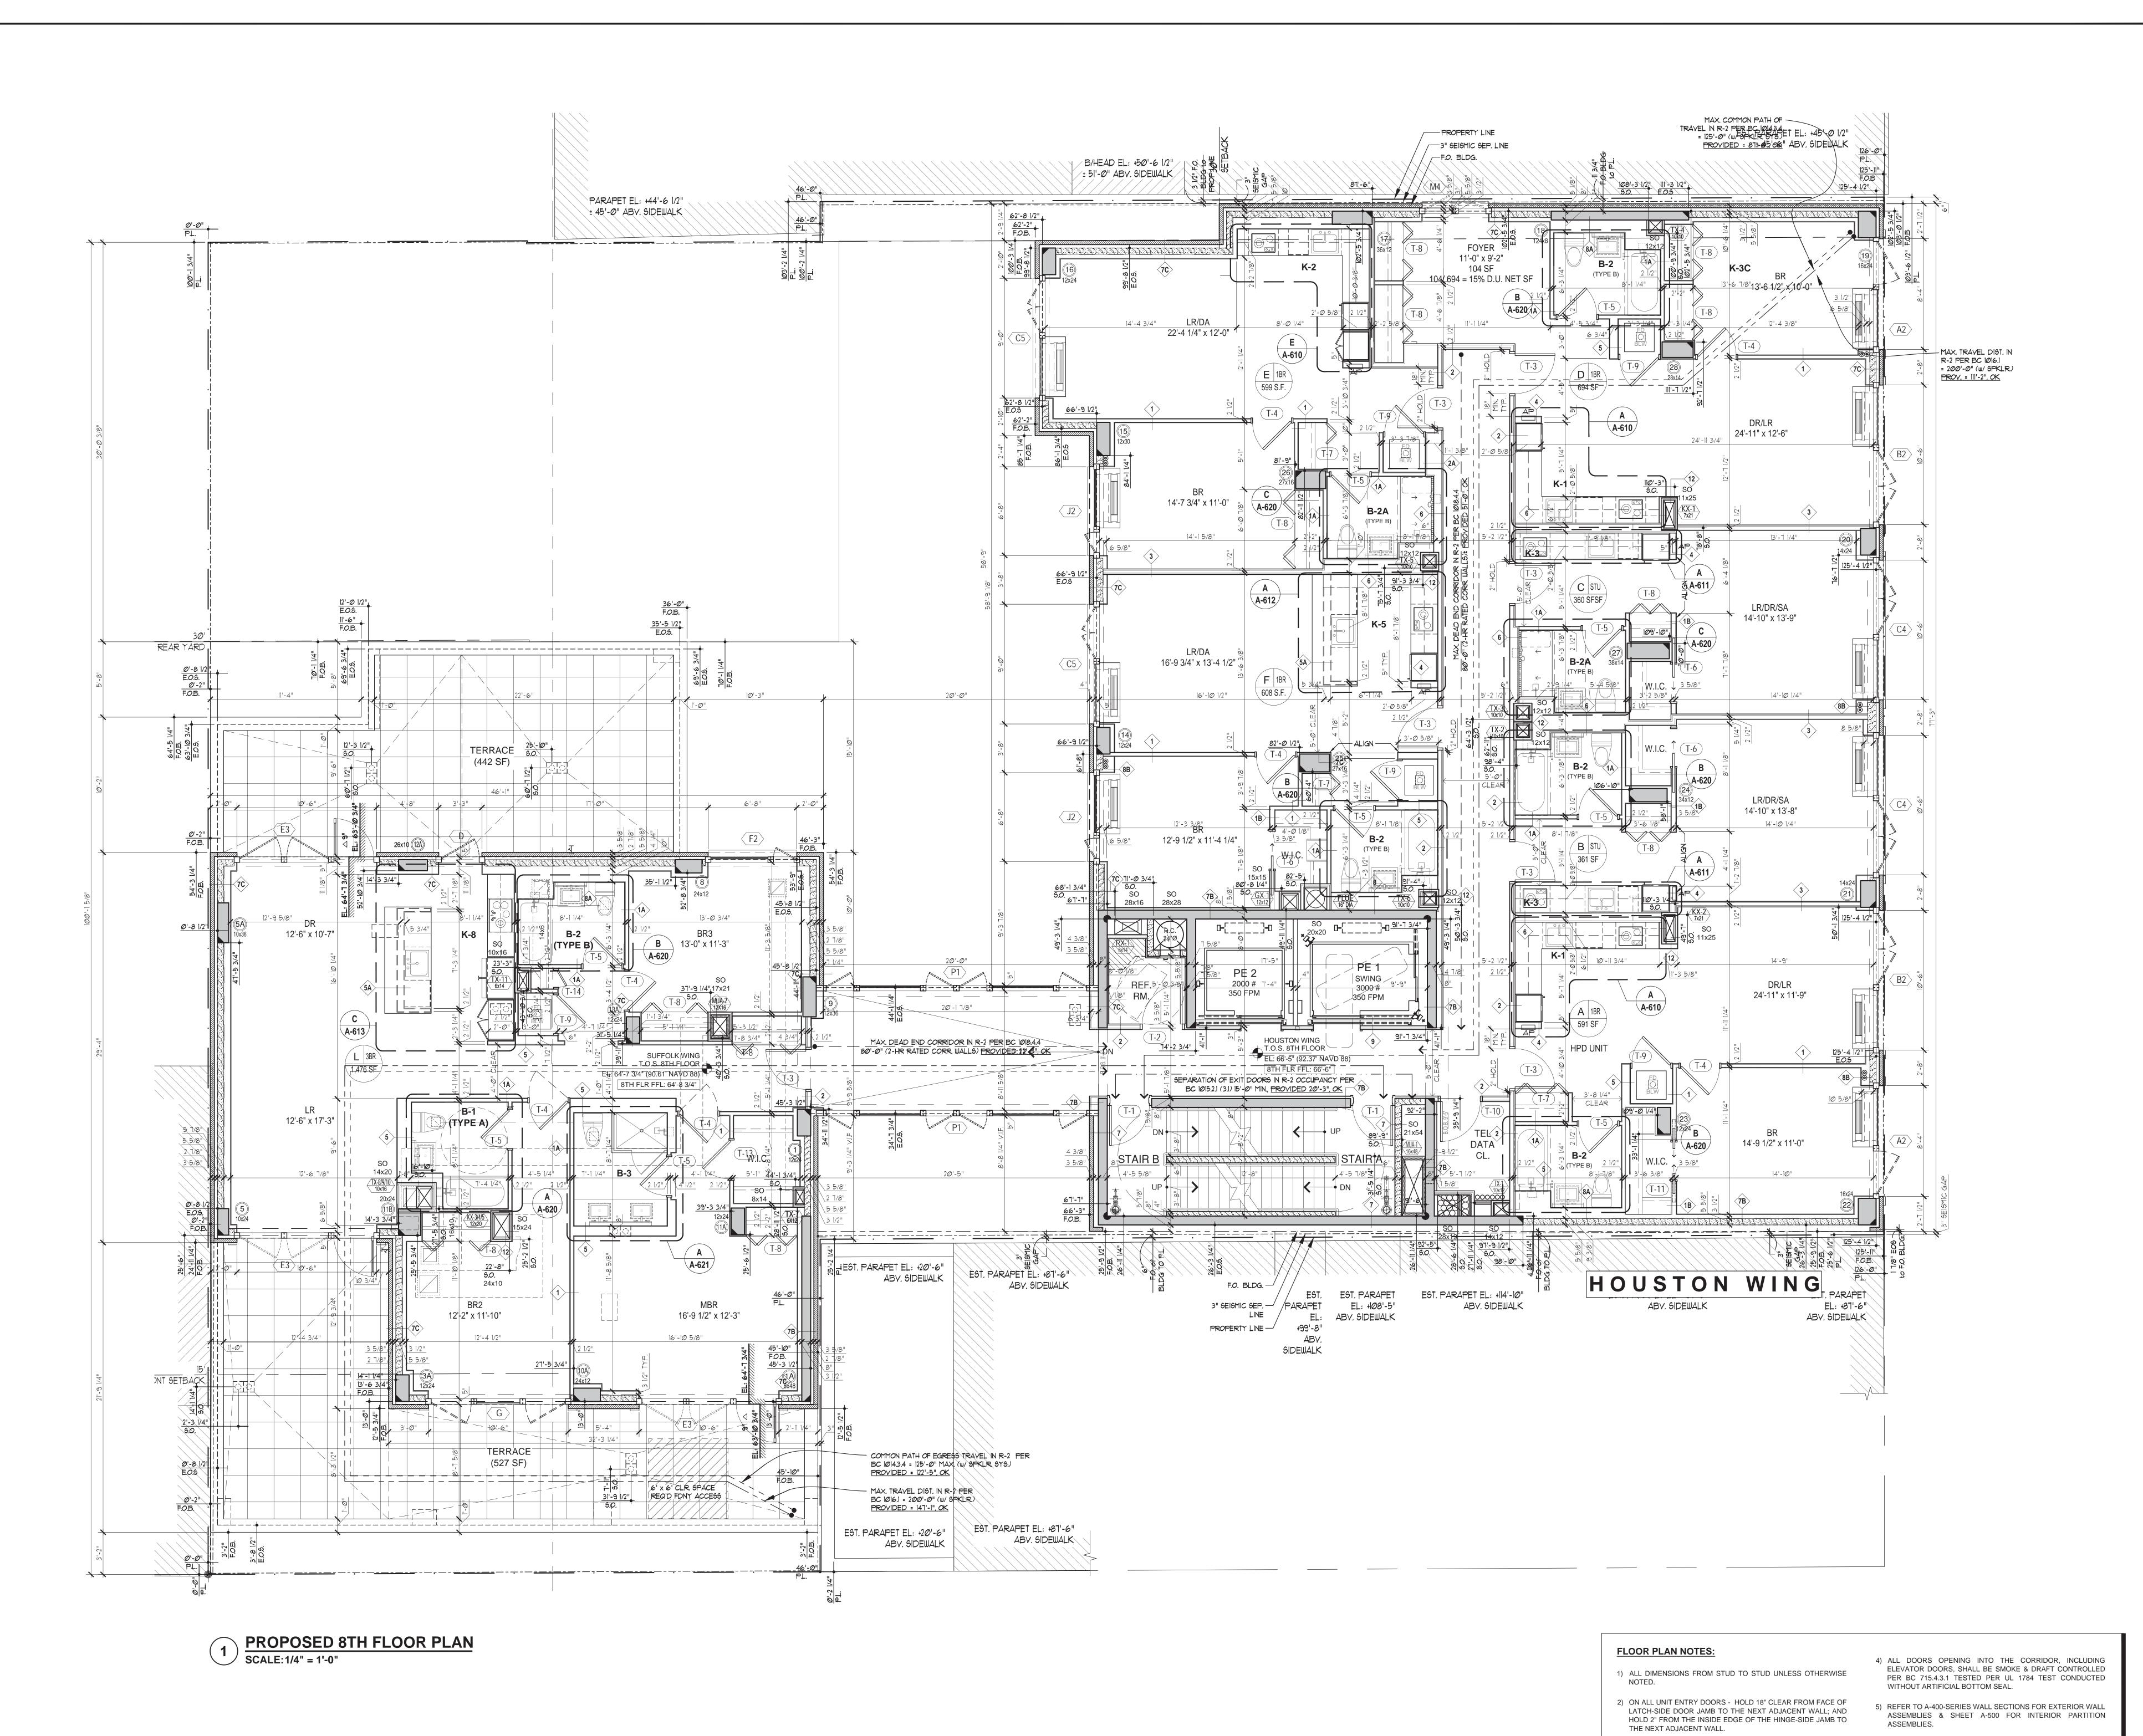



 DATE:
 08/14/2015

 PROJECT#:
 1446

 DRAWING SCALE:
 AS NOTED
 G:/1446 - A-100-110 - FLOOR PLANS.dwg





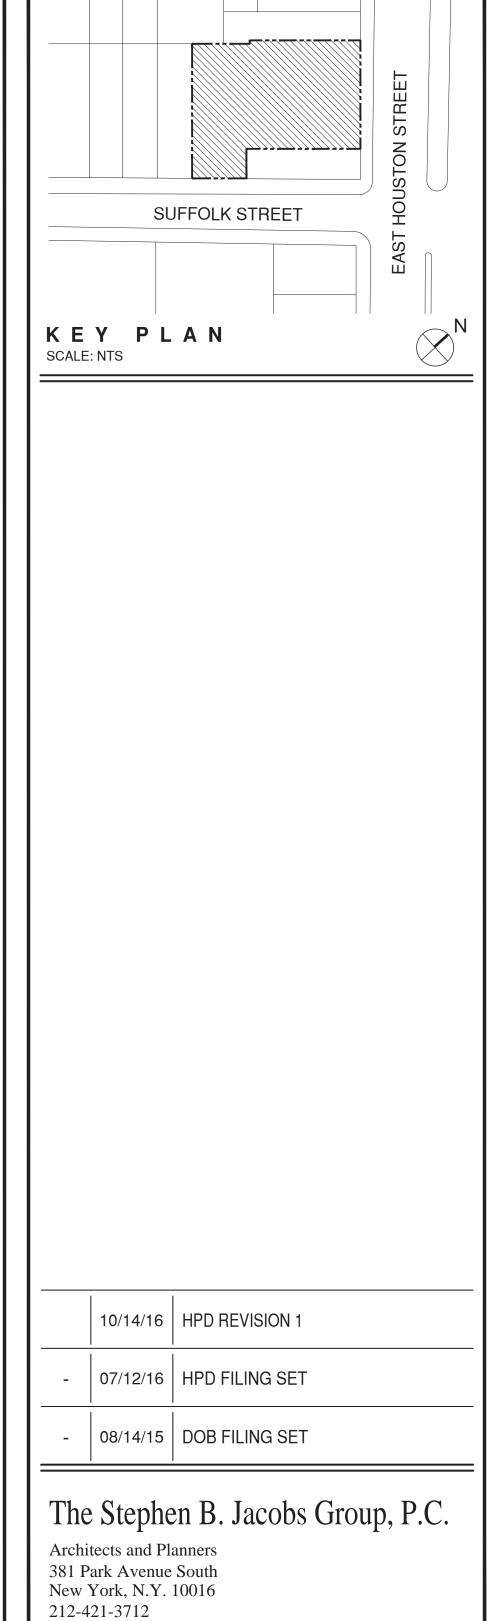

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DOB# 121189711

255 EAST HOUSTON ST. MANHATTAN, N.Y. 10002

Drawing Title:

6) ENSURE ALL RATED INTERIOR DEMISING PARTITIONS ARE FULLY FIRE-SAFED IN CONNECTING TO THE EXTERIOR WALL,


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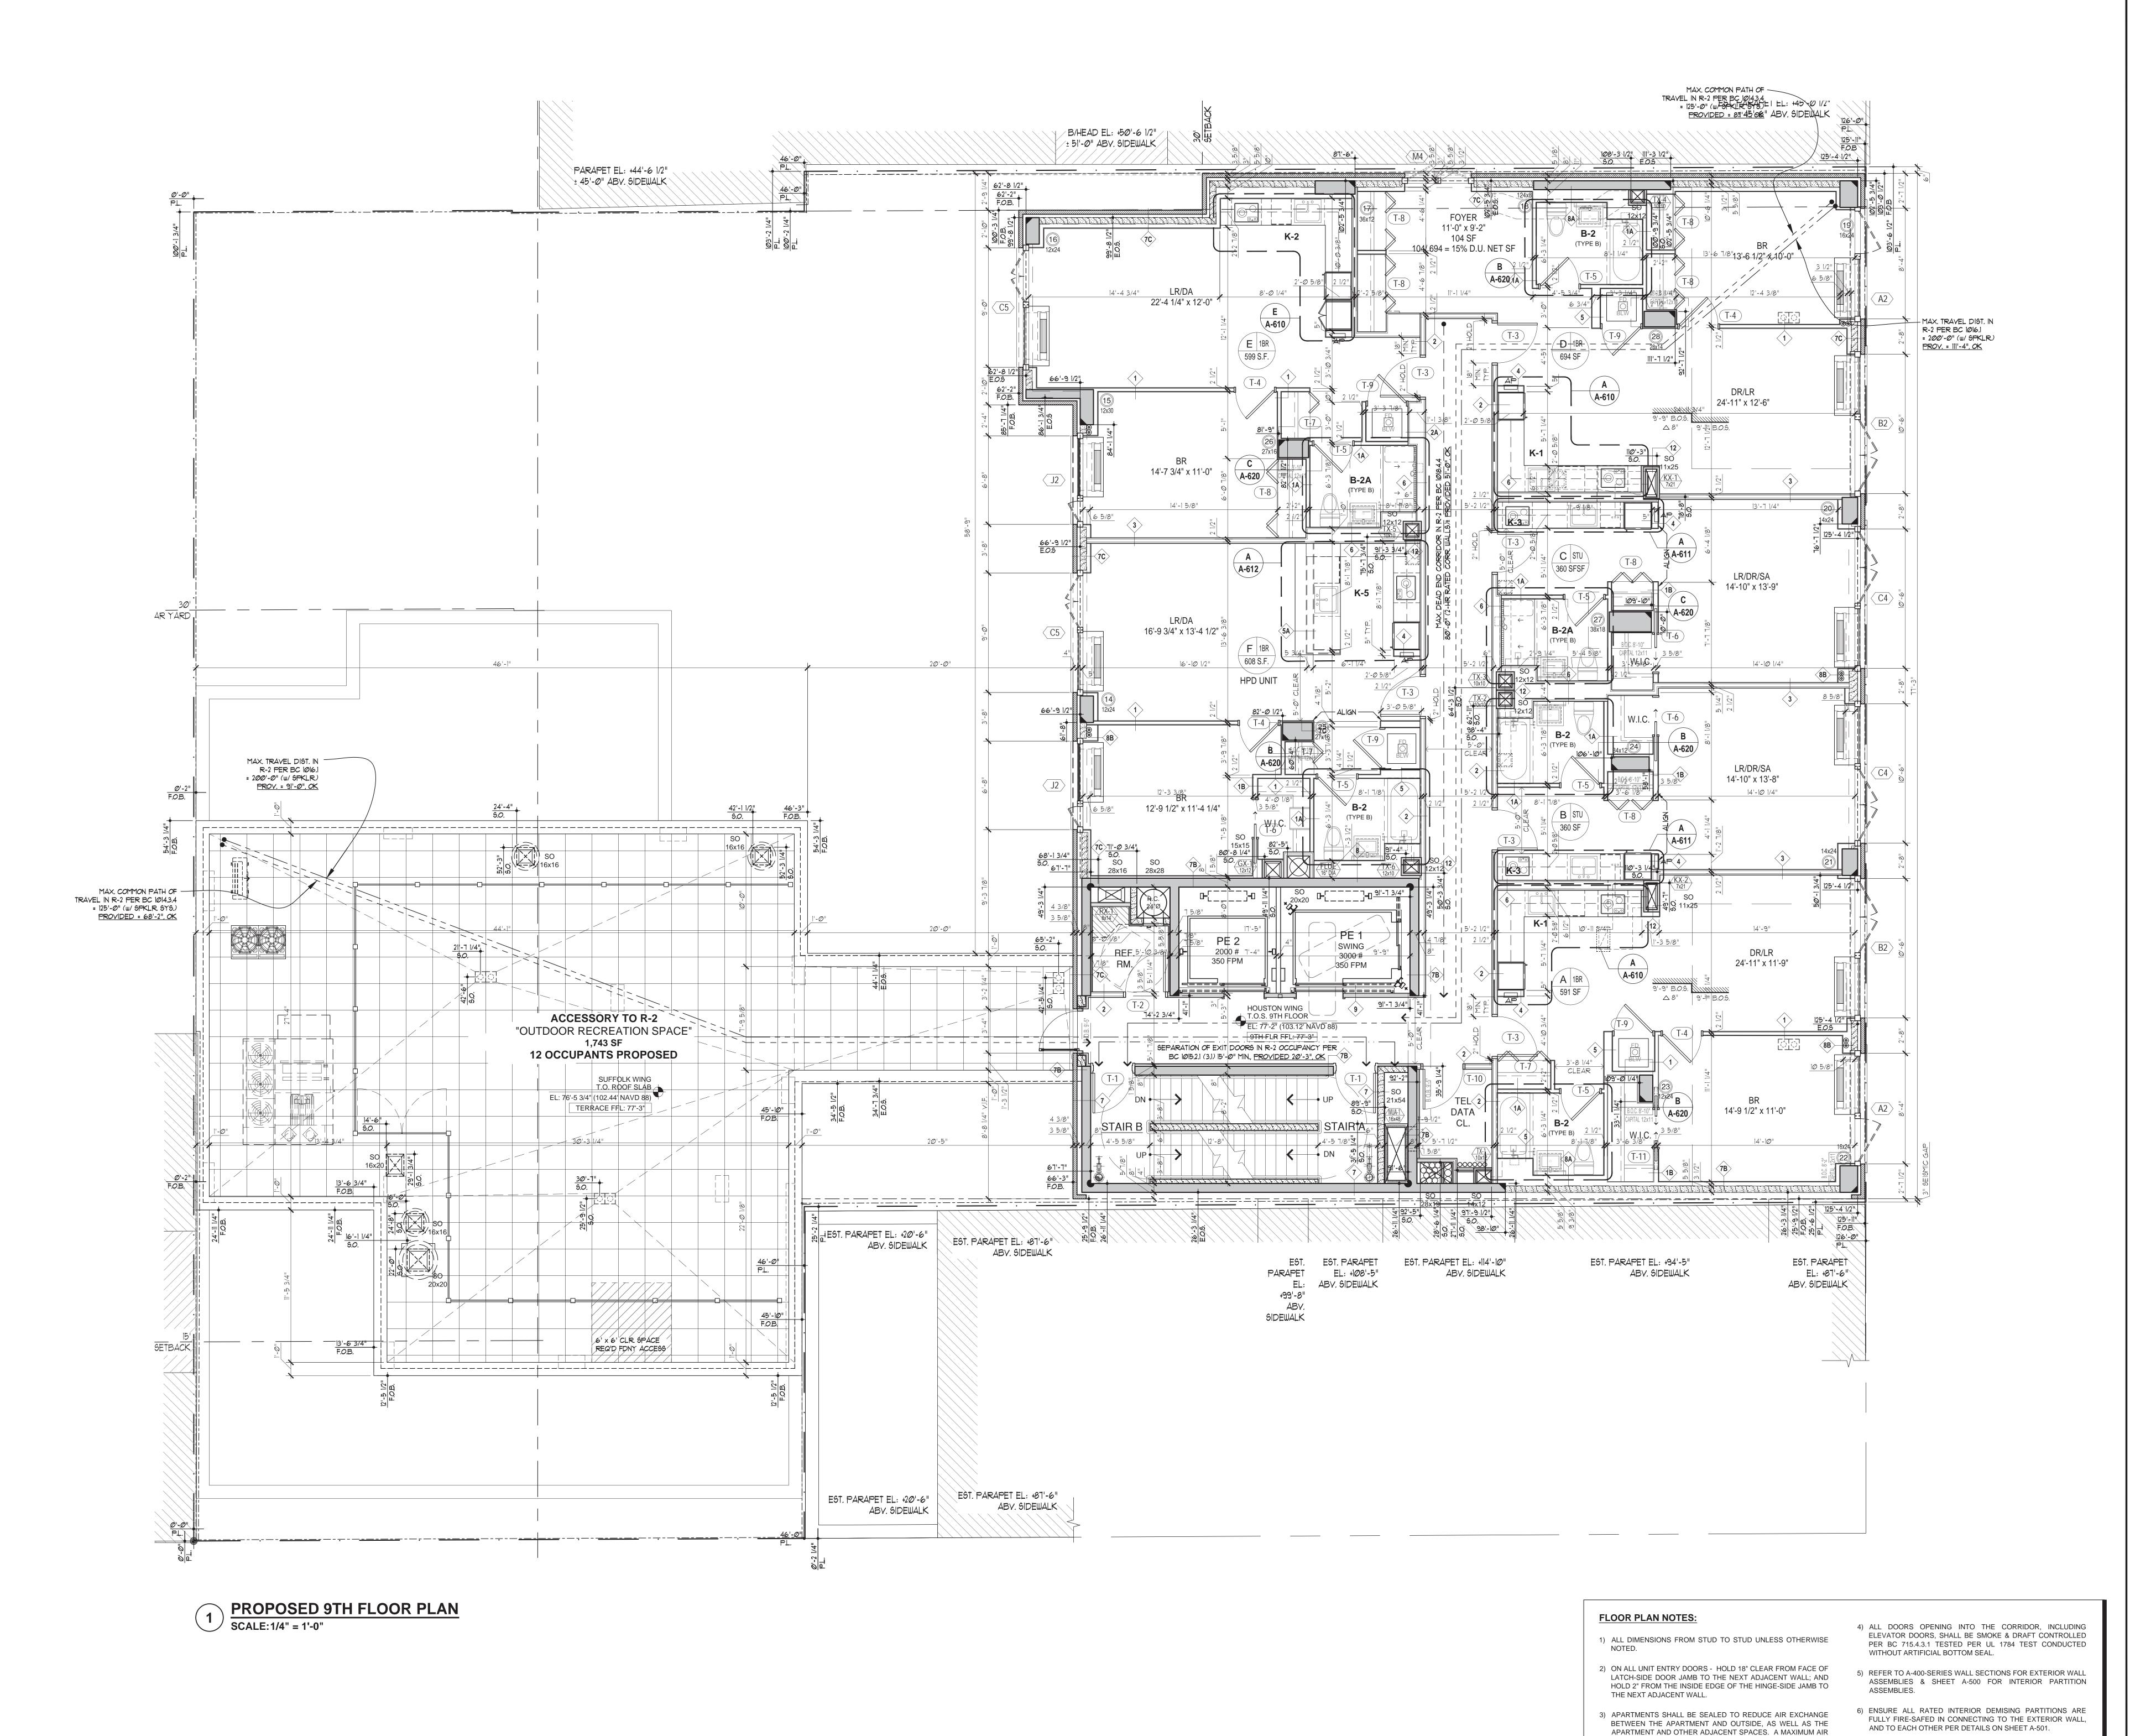
AND TO EACH OTHER PER DETAILS ON SHEET A-501.


DRAWINGS & SPECIFICATIONS.

3) APARTMENTS SHALL BE SEALED TO REDUCE AIR EXCHANGE BETWEEN THE APARTMENT AND OUTSIDE, AS WELL AS THE

APARTMENT AND OTHER ADJACENT SPACES. A MAXIMUM AIR LEAKAGE RATE OF 0.30 CFM PER SQ. FT. OF ENCLOSURE IS 8TH FLOOR PLAN



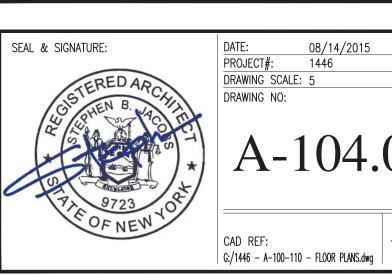

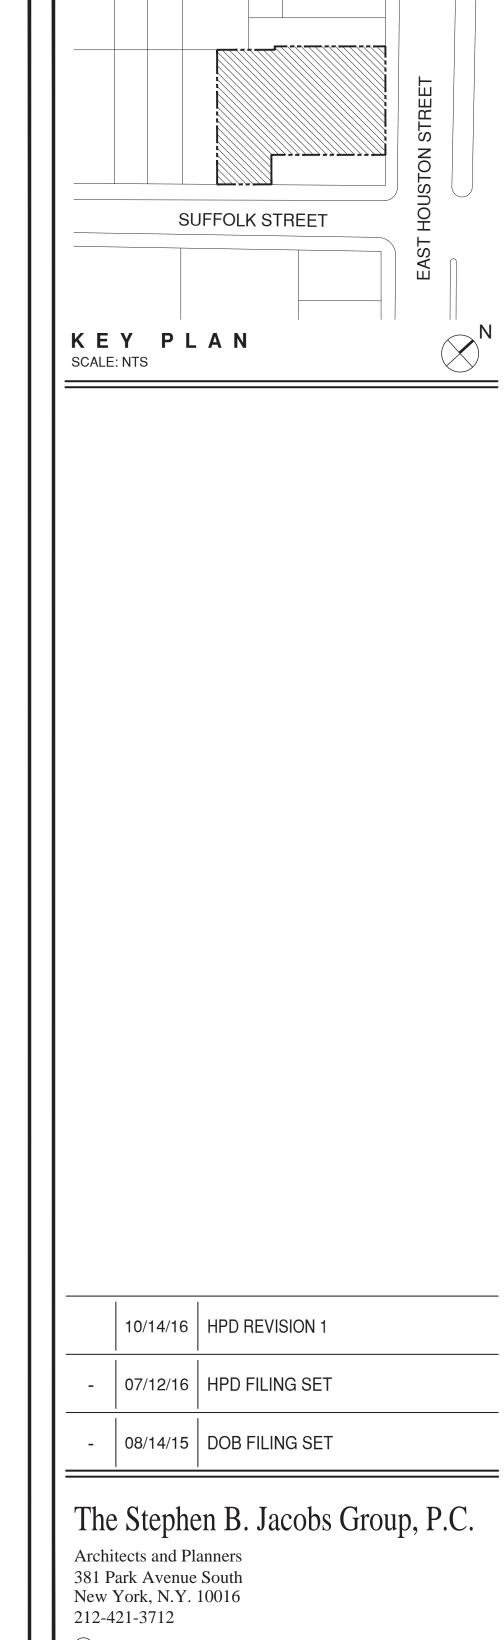

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DOB# 121189711

255 EAST HOUSTON ST. MANHATTAN, N.Y. 10002

Drawing Title:

7) ACOUSTIC & THERMAL INSULATION TO BE ENSURED PER


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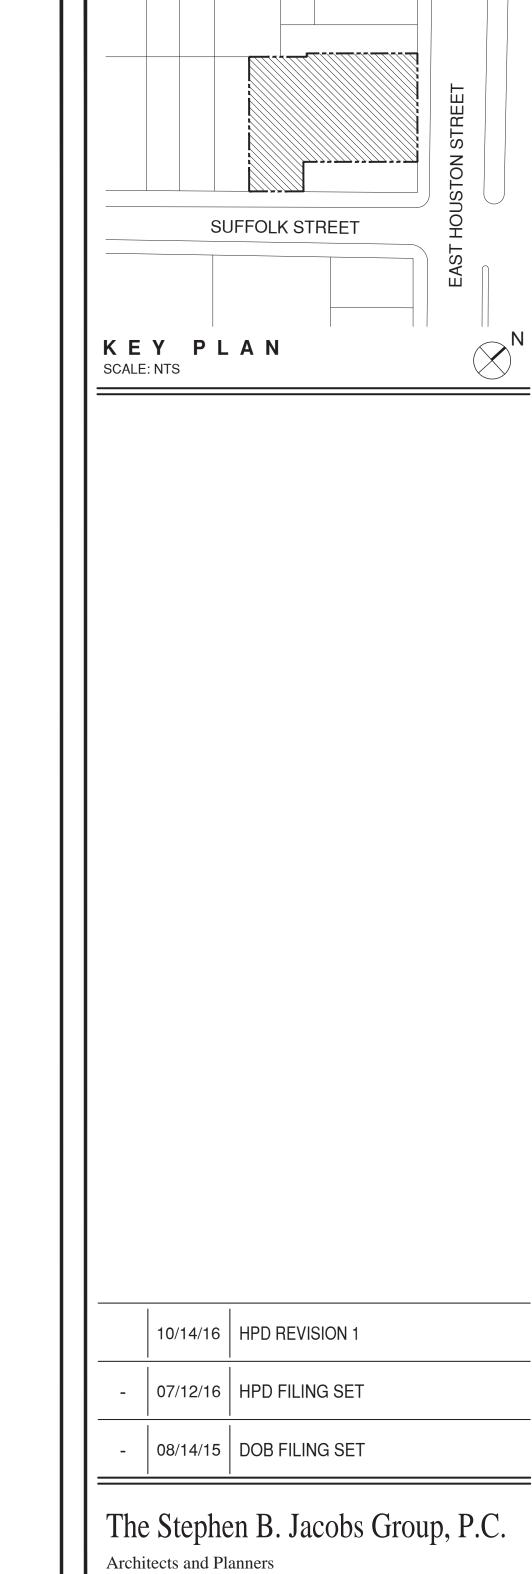
LEAKAGE RATE OF 0.30 CFM PER SQ. FT. OF ENCLOSURE IS

9TH FLOOR PLAN



PROJECT#: 1446 DRAWING SCALE: AS NOTED G:/1446 - A-100-110 - FLOOR PLANS.dwg



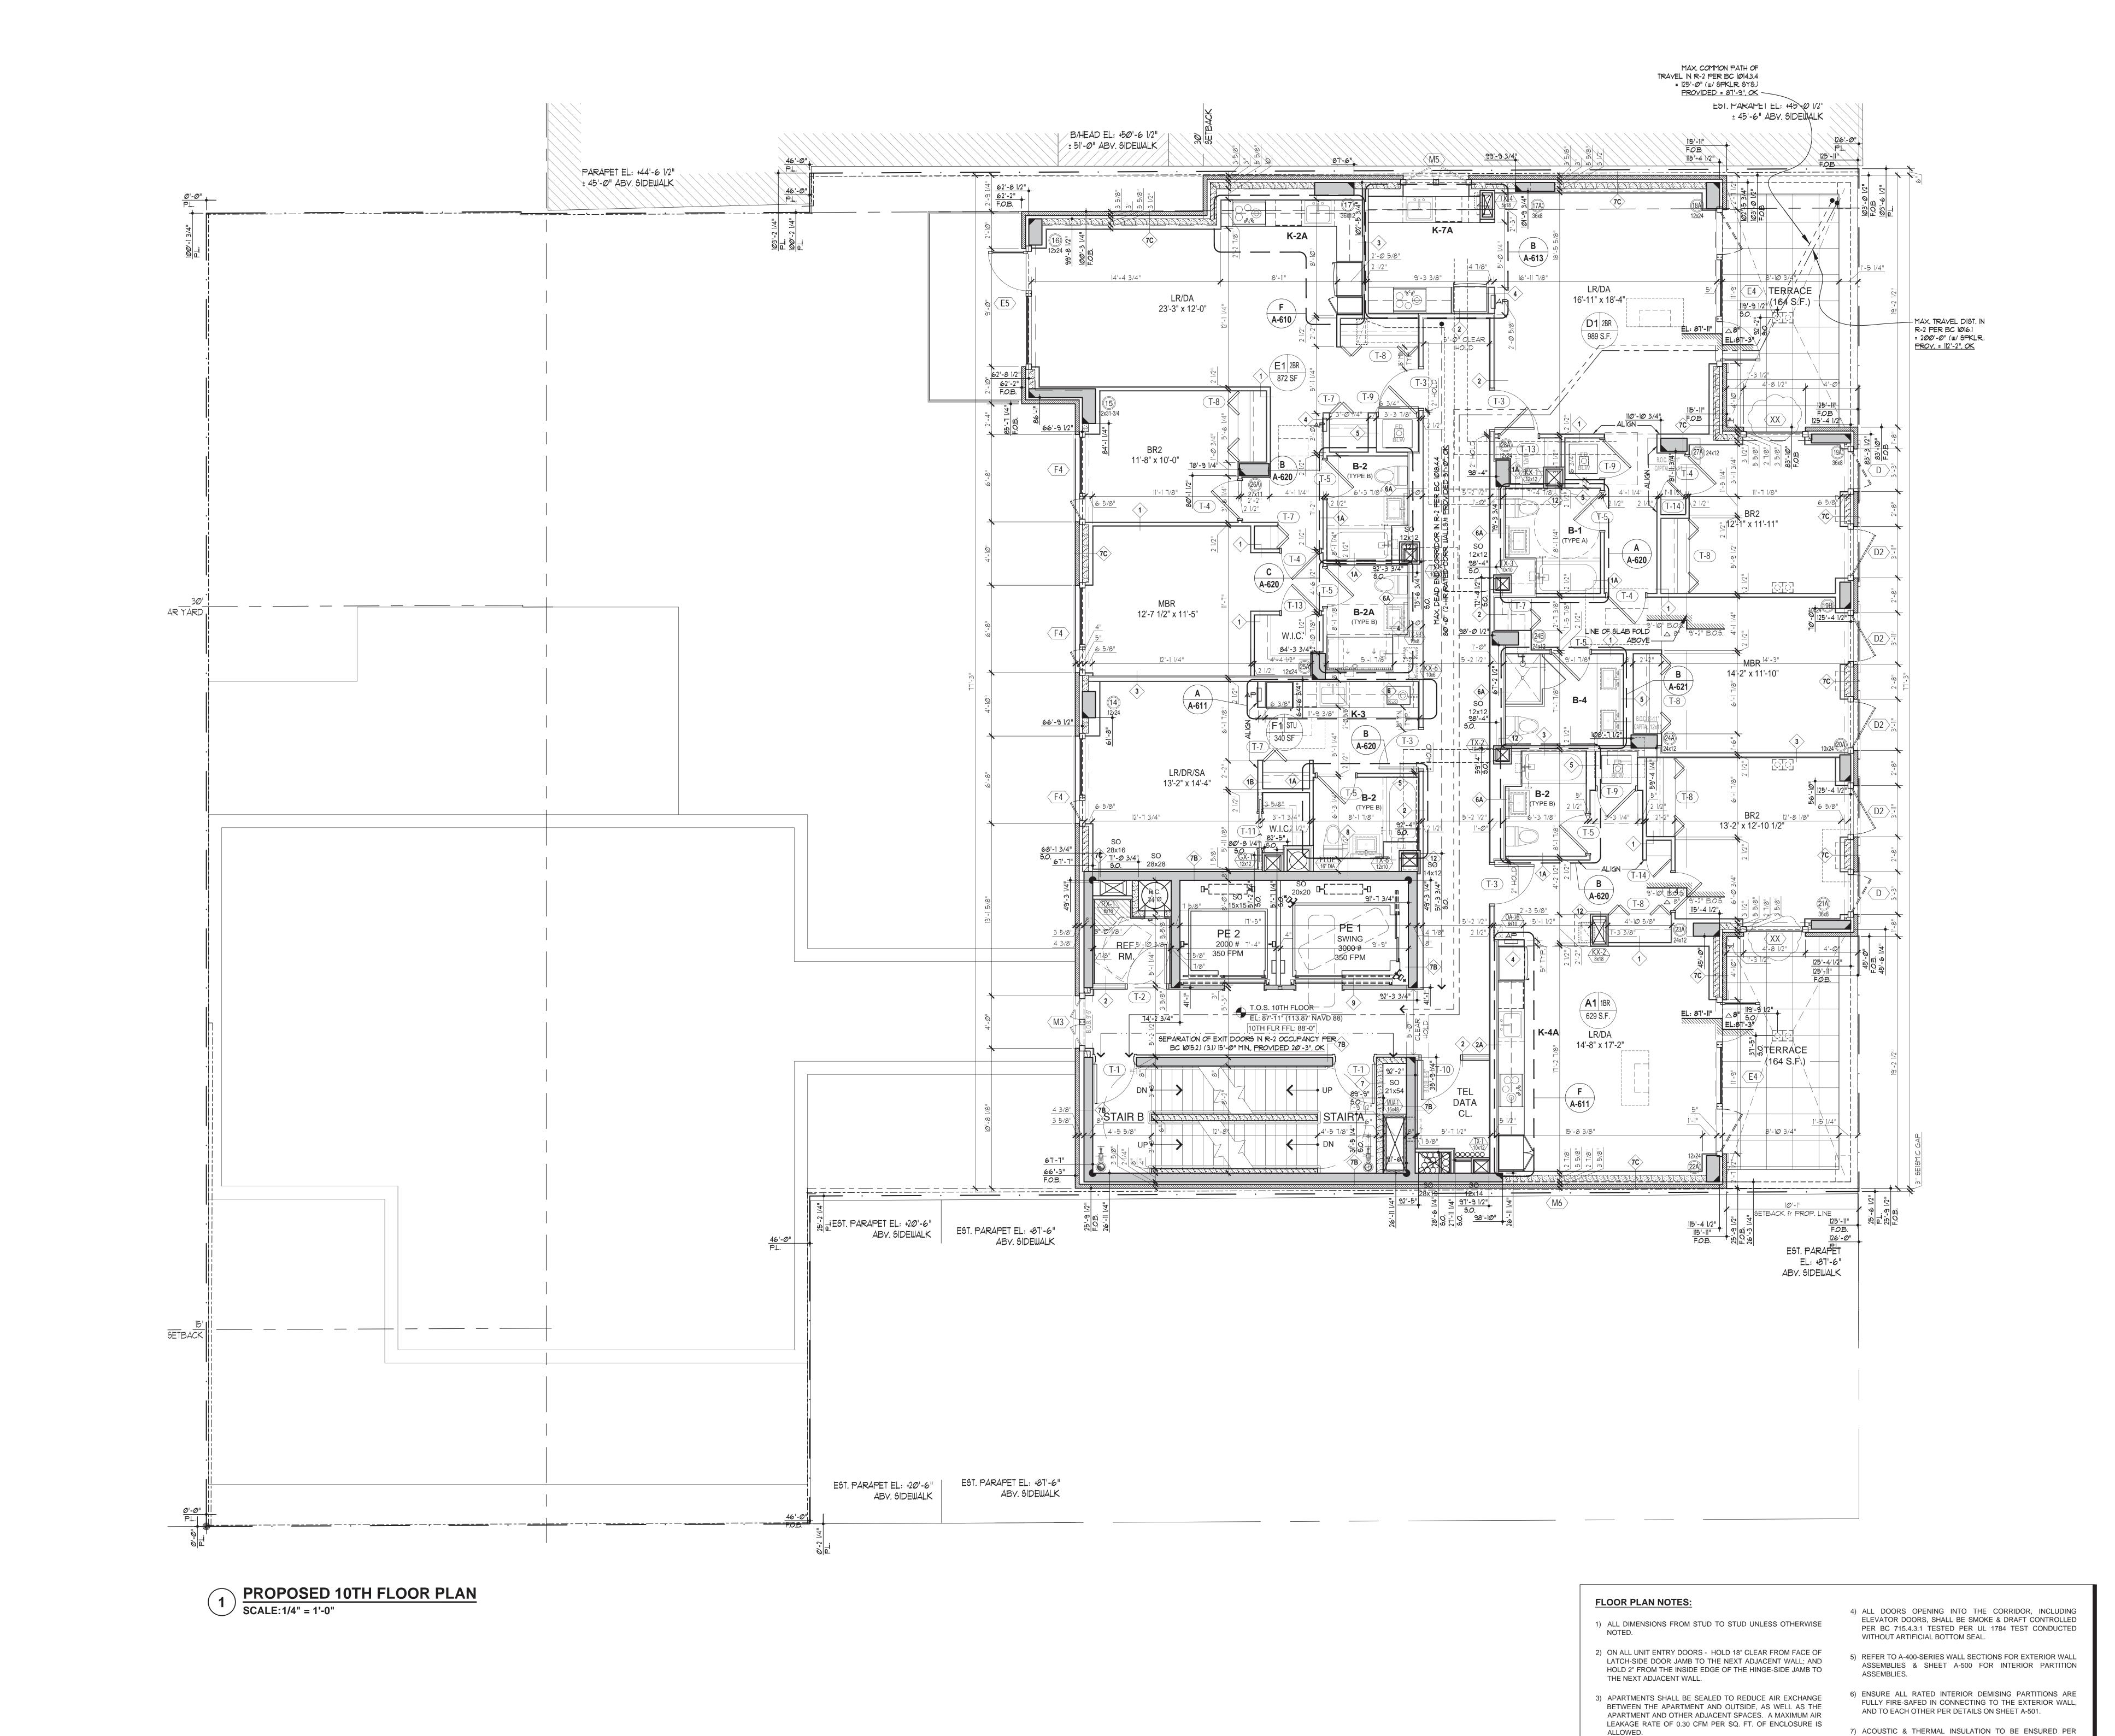

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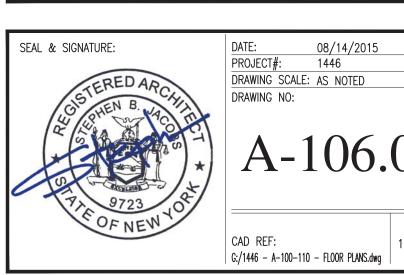
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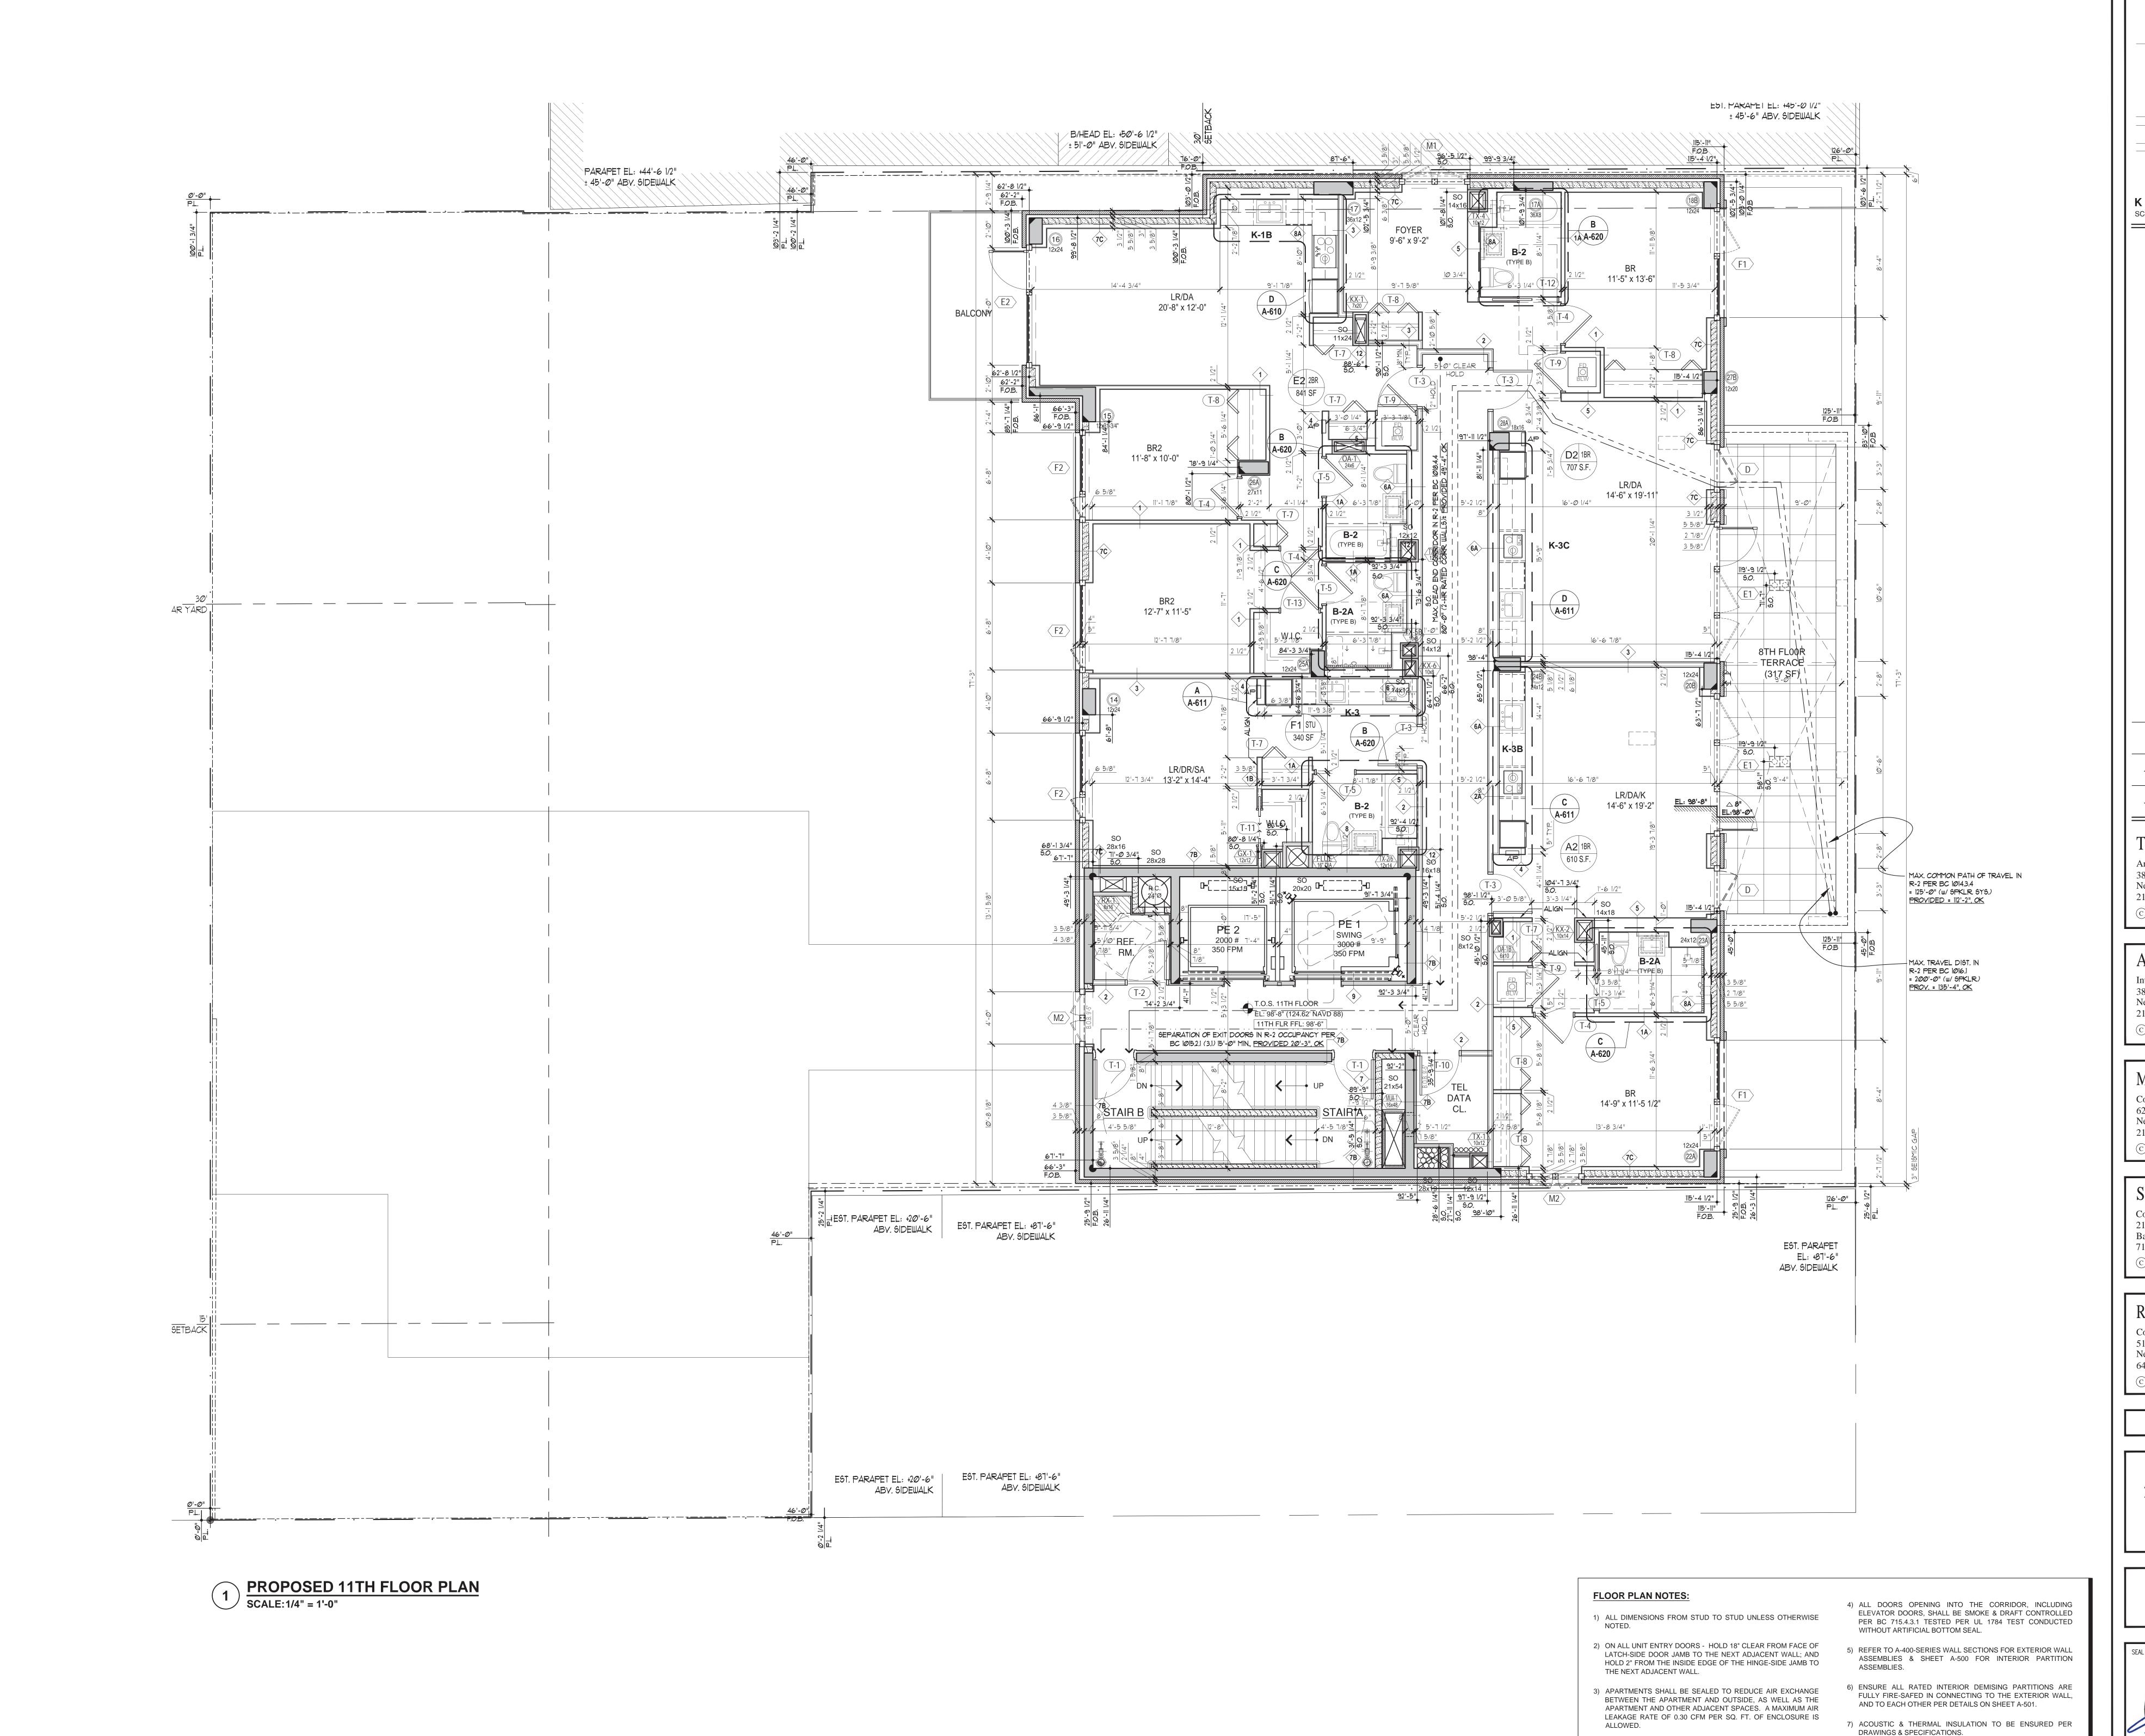
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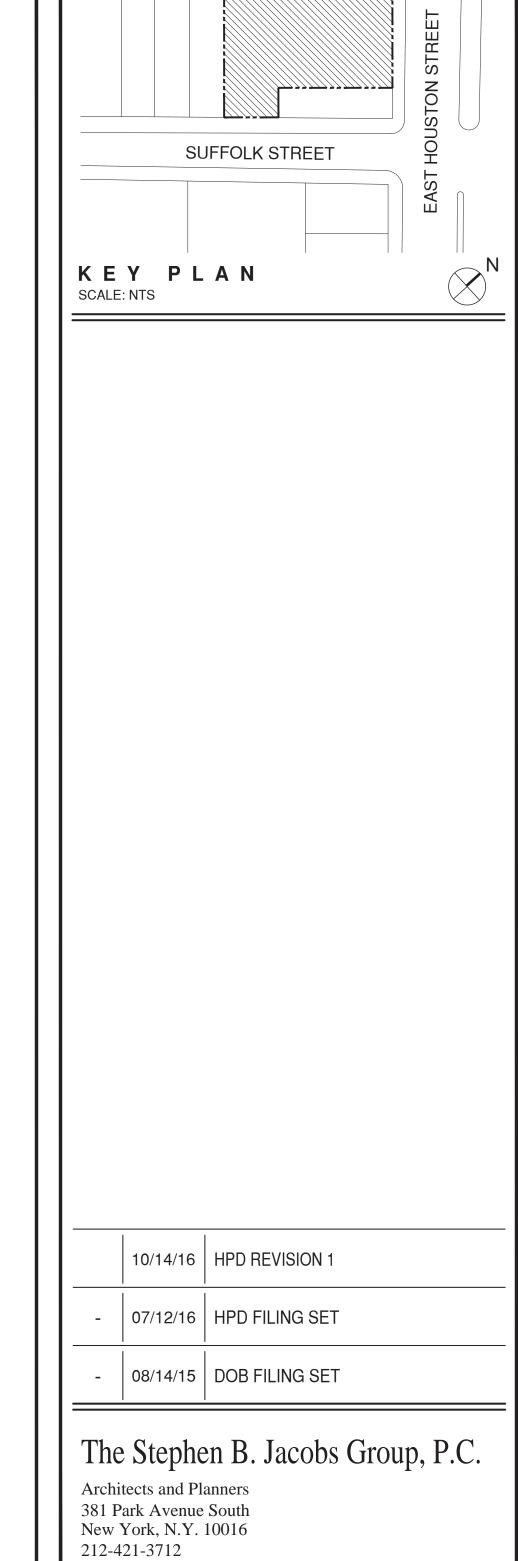
Drawing Title:

DRAWINGS & SPECIFICATIONS.

10TH FLOOR PLAN







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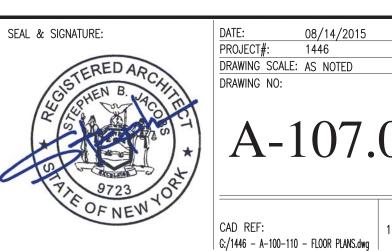
Consulting Engineers (Support of Excavation) 512 7th Avenue New York, N.Y. 10018 646-484-3250


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255 EAST HOUSTON ST. MANHATTAN, N.Y. 10002

Drawing Title:

11TH FLOOR PLAN



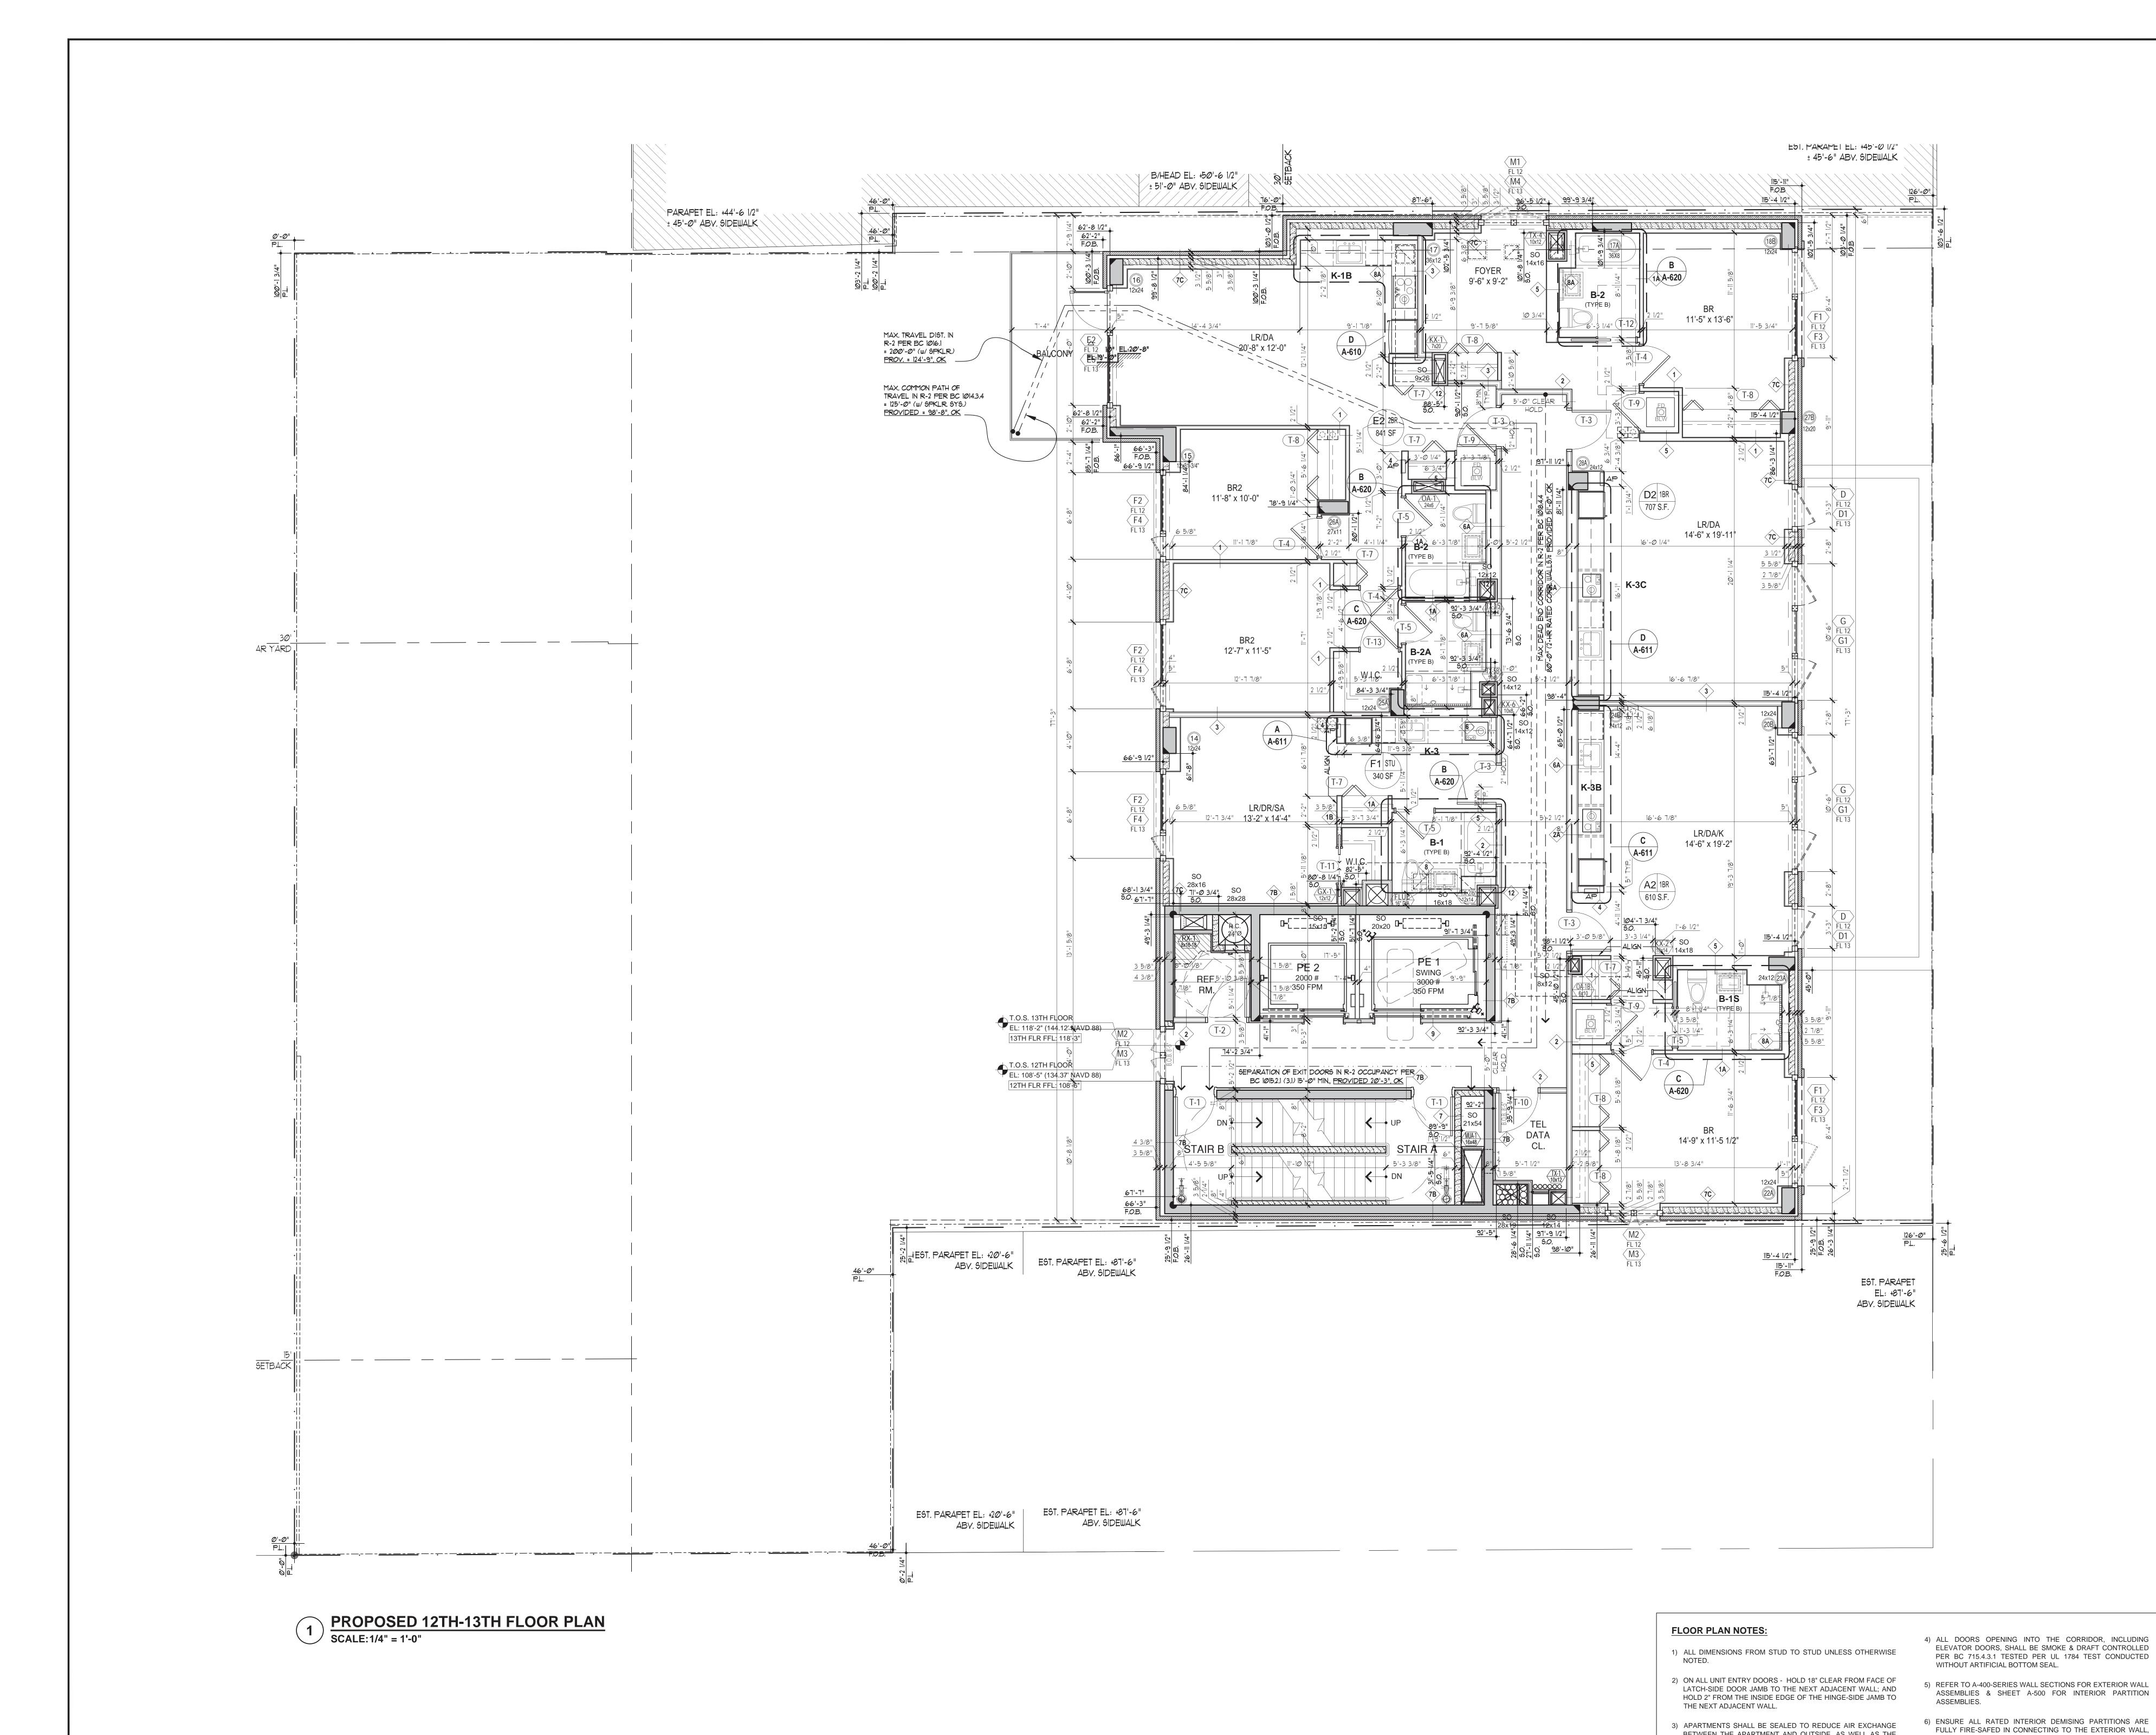

SUFFOLK STREET KEY PLAN SCALE: NTS 10/14/16 | HPD REVISION 1 - 07/12/16 HPD FILING SET - 08/14/15 DOB FILING SET

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DOB# 121189711

255 EAST HOUSTON ST. MANHATTAN, N.Y. 10002

Drawing Title:

AND TO EACH OTHER PER DETAILS ON SHEET A-501.

DRAWINGS & SPECIFICATIONS.

7) ACOUSTIC & THERMAL INSULATION TO BE ENSURED PER


BETWEEN THE APARTMENT AND OUTSIDE, AS WELL AS THE


APARTMENT AND OTHER ADJACENT SPACES. A MAXIMUM AIR LEAKAGE RATE OF 0.30 CFM PER SQ. FT. OF ENCLOSURE IS

ALLOWED.

12TH-13TH FLOOR PLAN



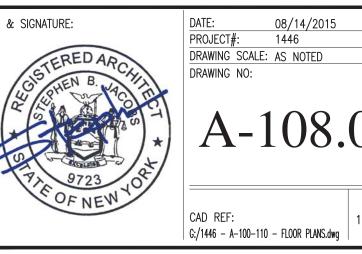

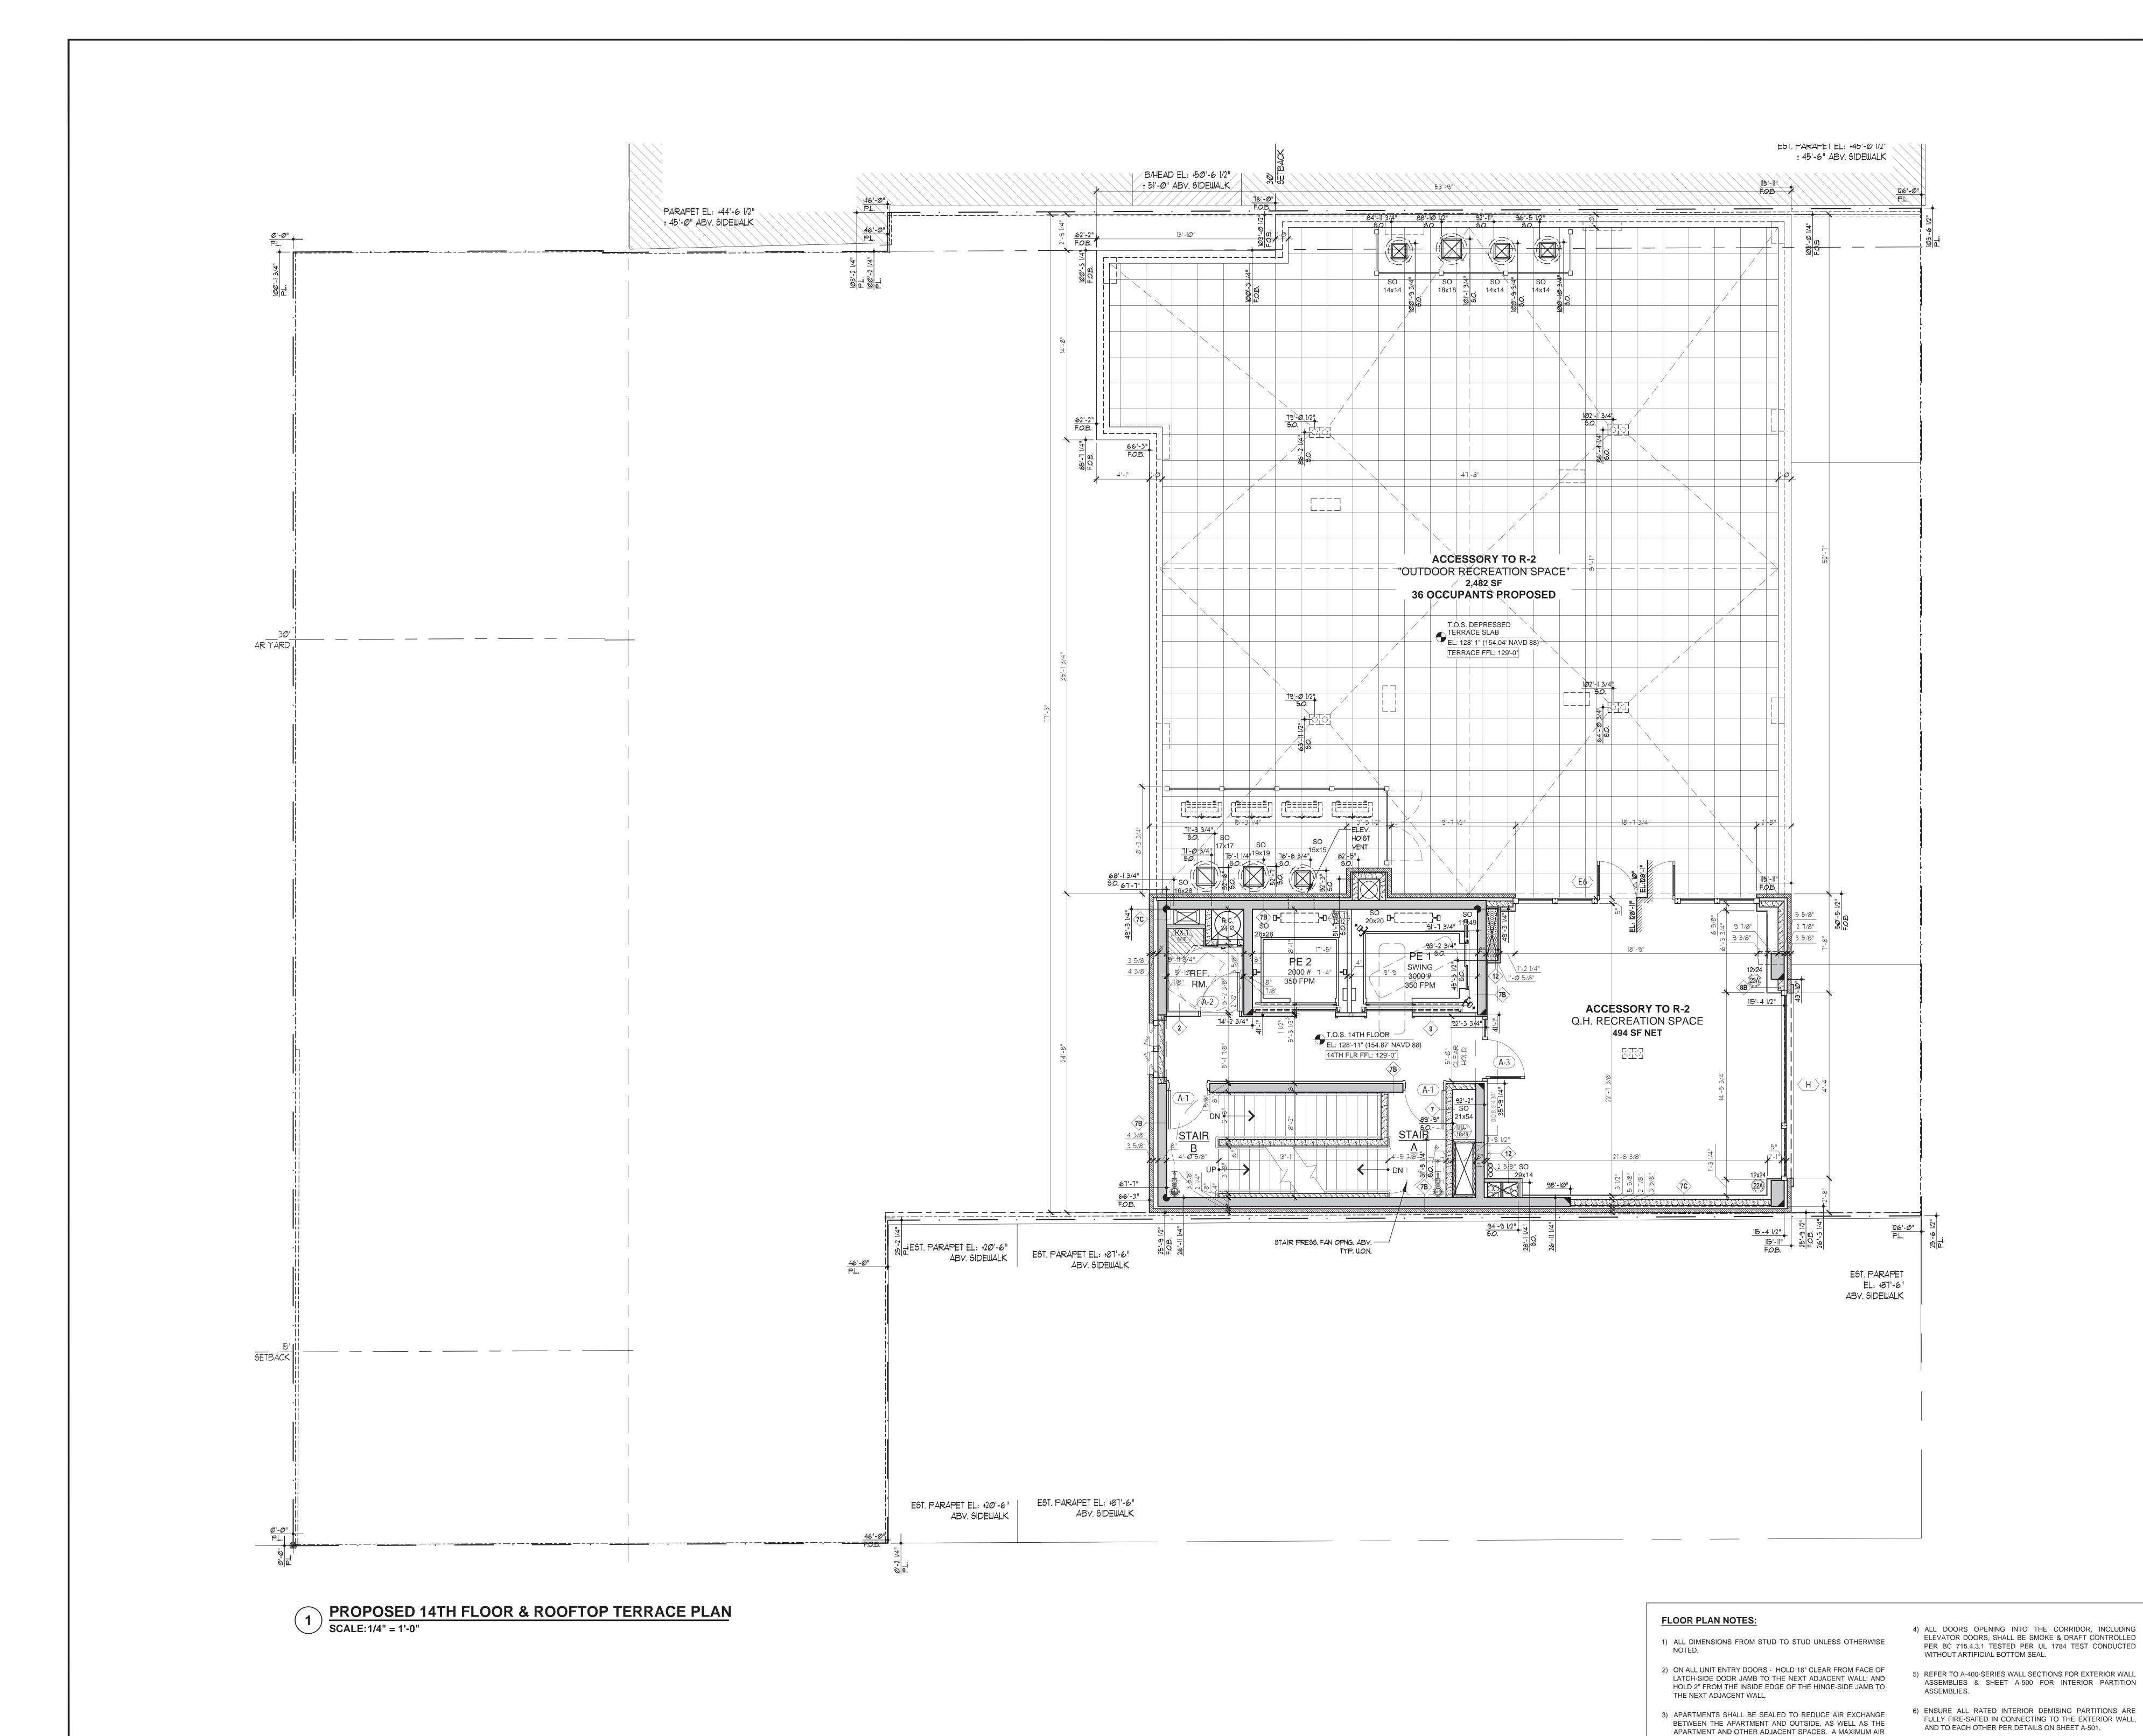

SUFFOLK STREET

| 10/14/16 | HPD REVISION 1
| 07/12/16 | HPD FILING SET
| 08/14/15 | DOB FILING SET
| 08/14/15 | DOB FILING SET

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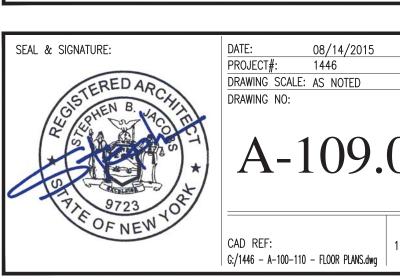
Consulting Engineers (Support of Excavation) 512 7th Avenue New York, N.Y. 10018 646-484-3250

DOB# 121189711

255 EAST HOUSTON ST. MANHATTAN, N.Y. 10002

Drawing Title:

14TH FLOOR AMENITY
& ROOFTOP TERRACE PLAN




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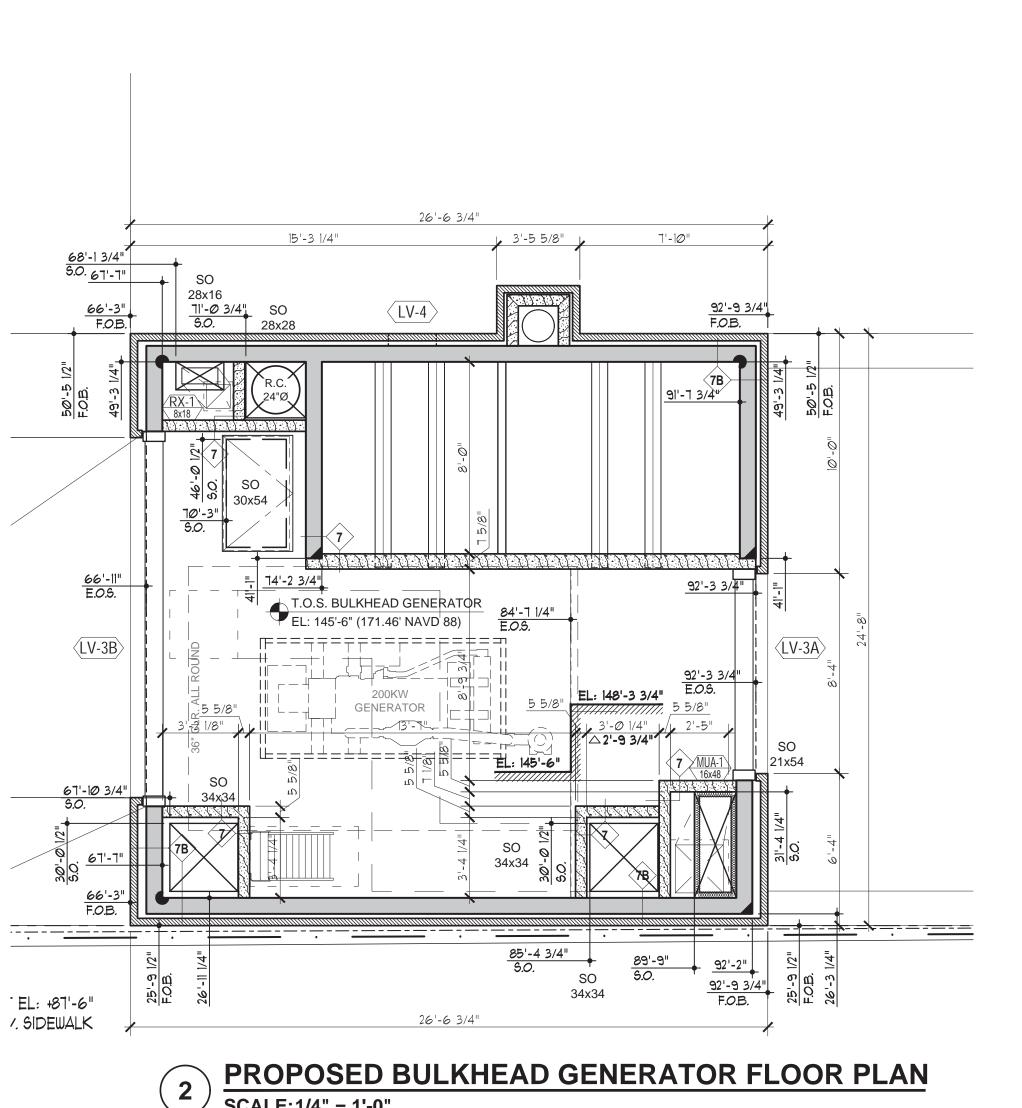
DRAWINGS & SPECIFICATIONS.

LEAKAGE RATE OF 0.30 CFM PER SQ. FT. OF ENCLOSURE IS


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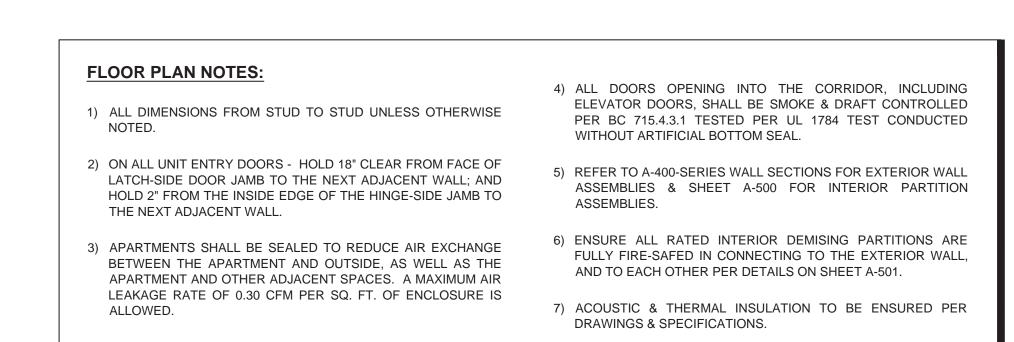



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ET EL: +87'-6" 3y. SIDEWALK ET EL: +87'-6" 3v. SIDEWALK EL: +87'-6" '. SIDEWALK

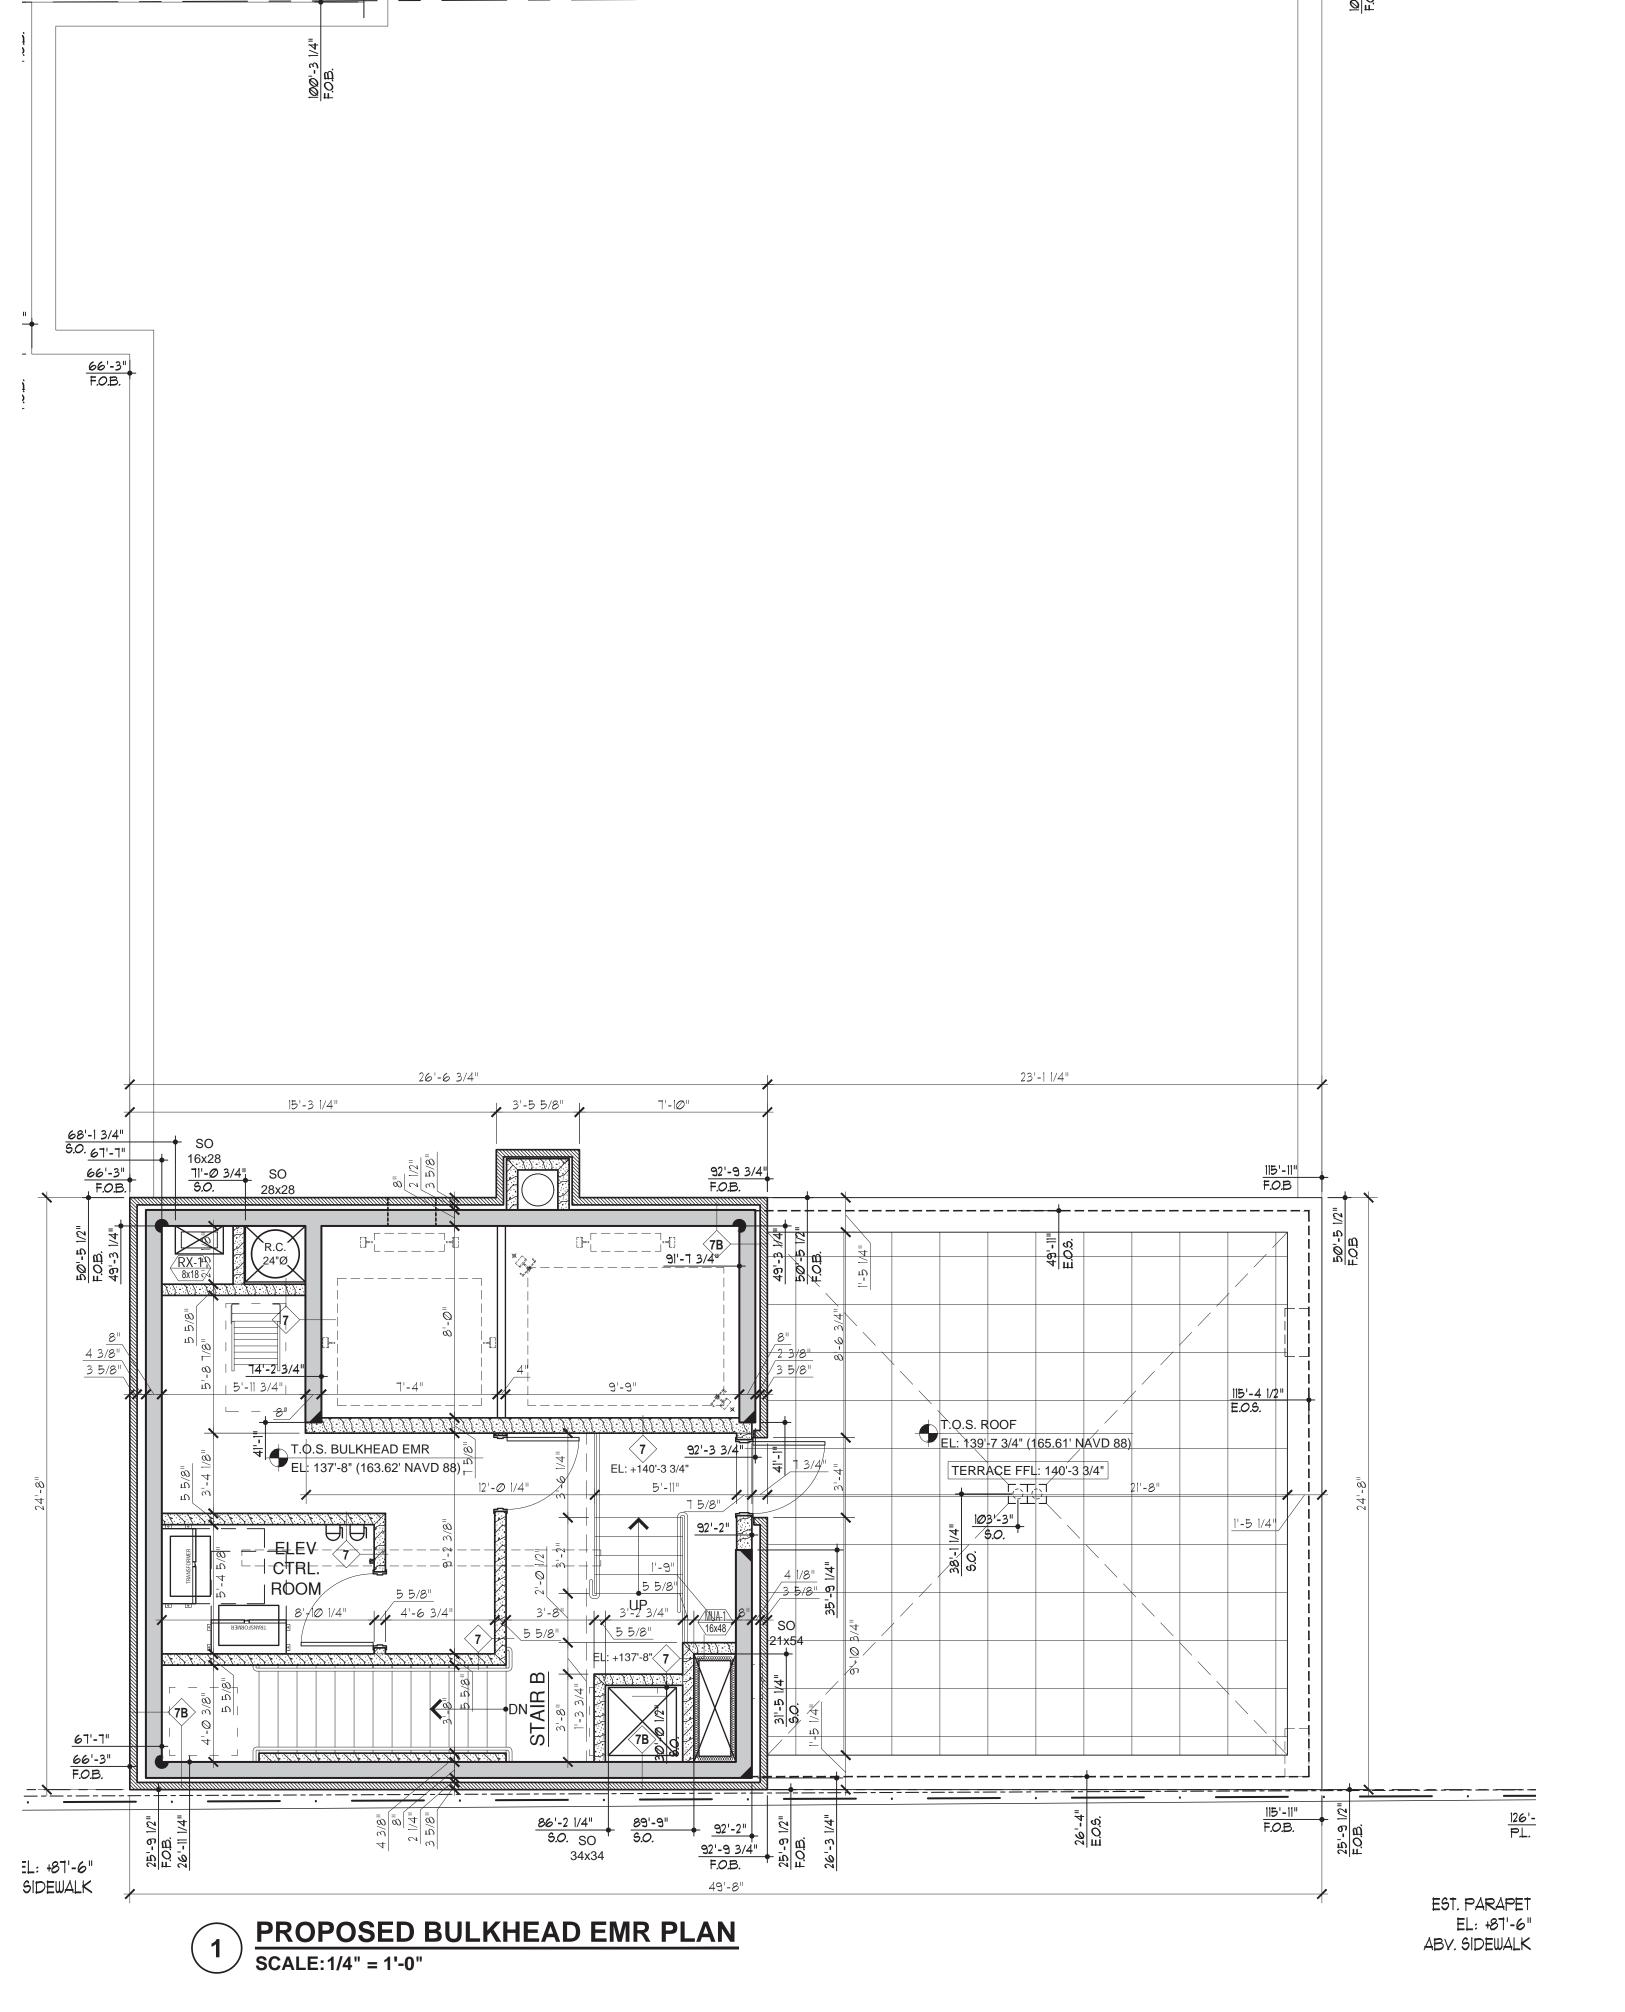E51. MARAMETEL: +45'-0 1/2" ± 45'-6" ABY, SIDEWALK



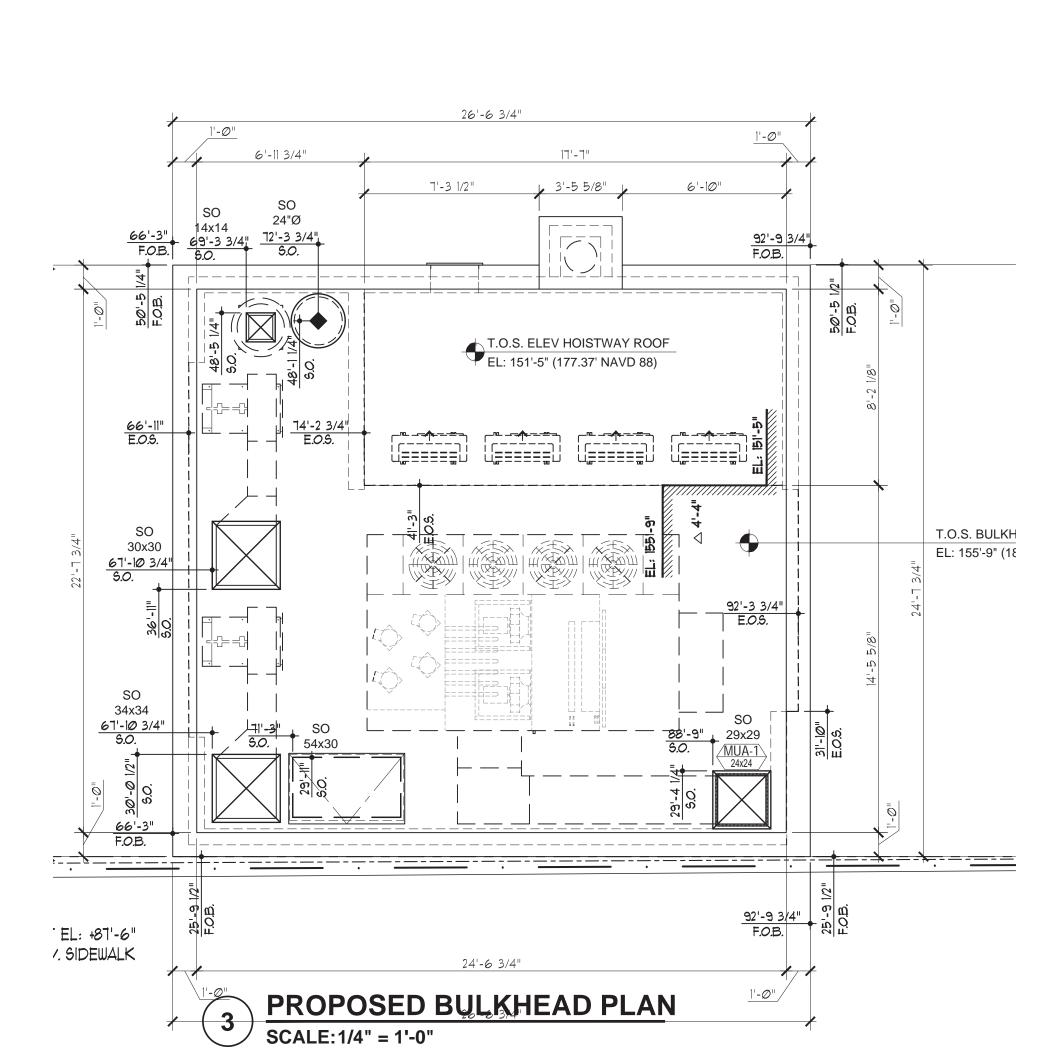

08/14/15 DOB FILING SET
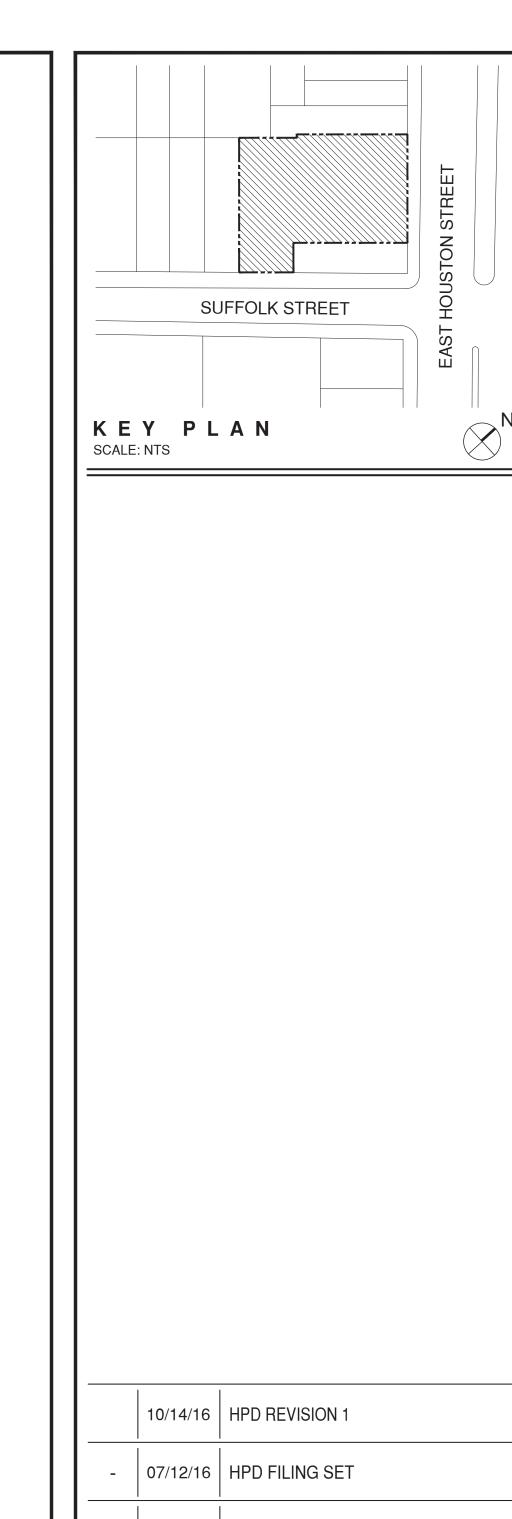
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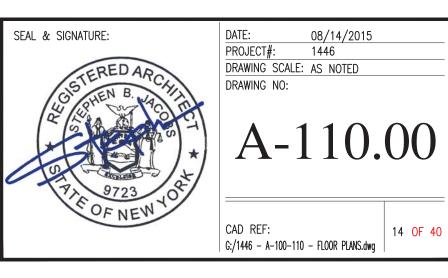
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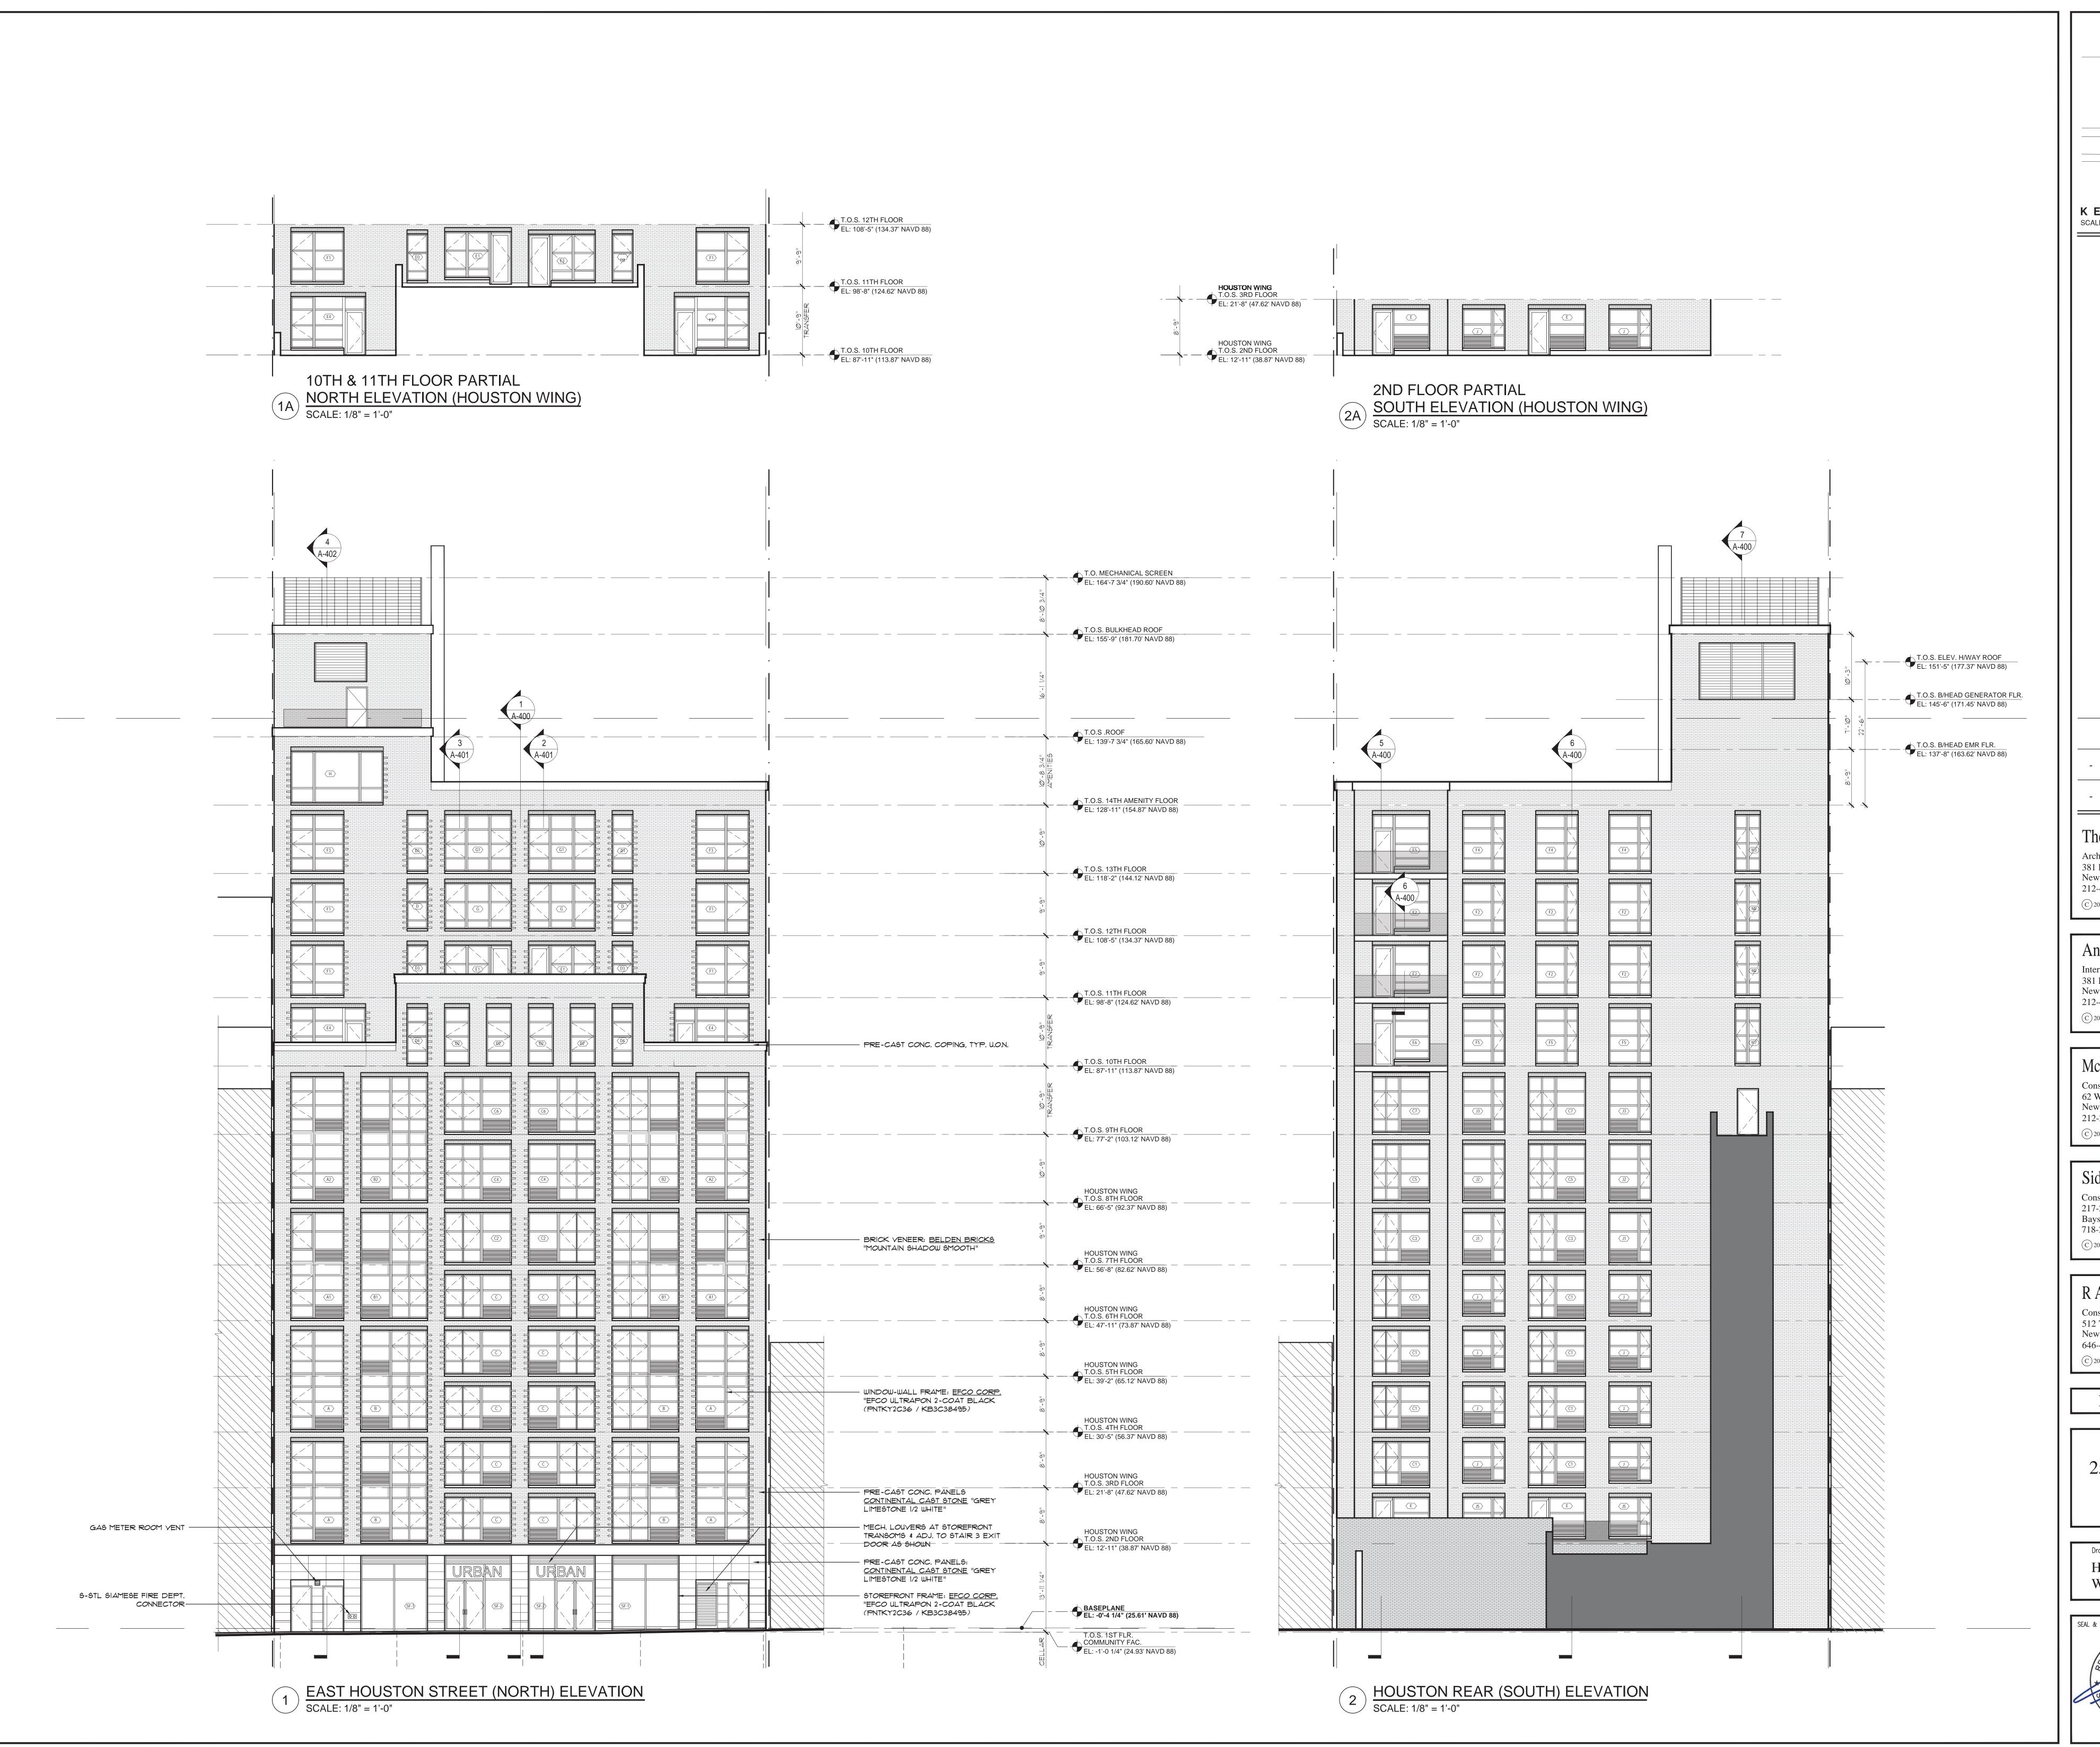
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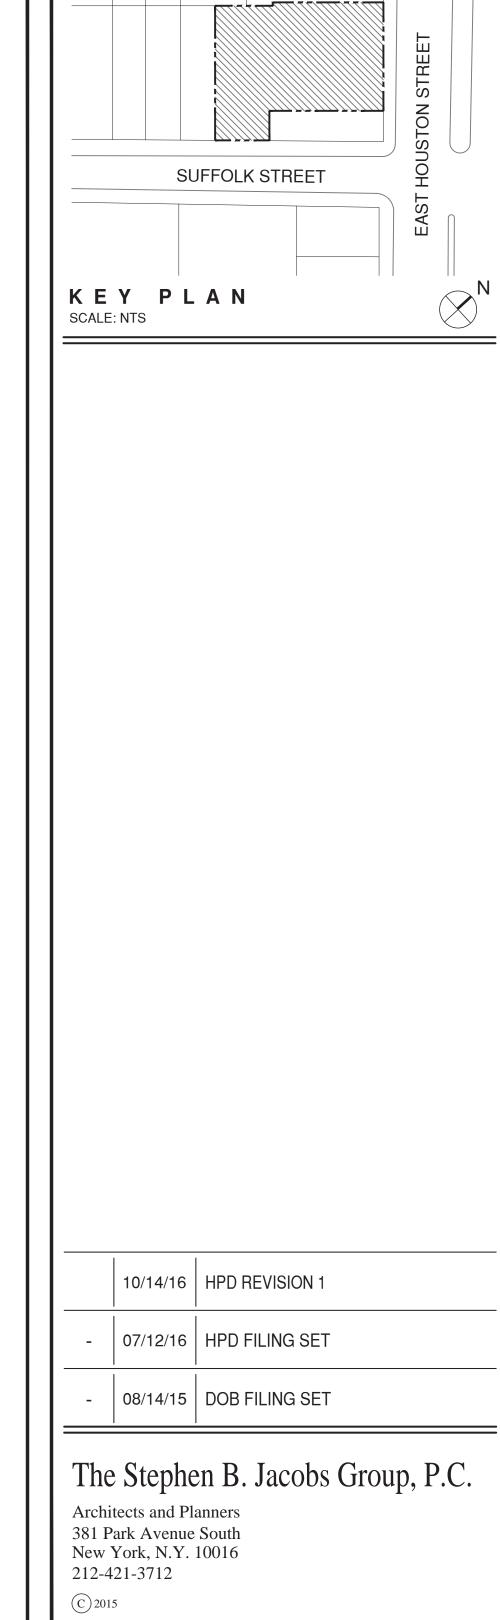
255 EAST HOUSTON ST. MANHATTAN, N.Y. 10002

Drawing Title:

BULKHEAD & ROOF PLANS







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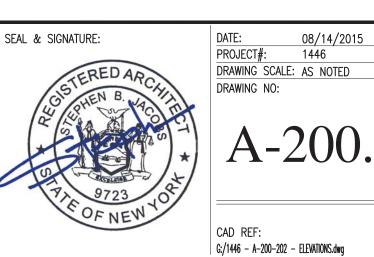
Consulting Engineers (Support of Excavation) 512 7th Avenue New York, N.Y. 10018


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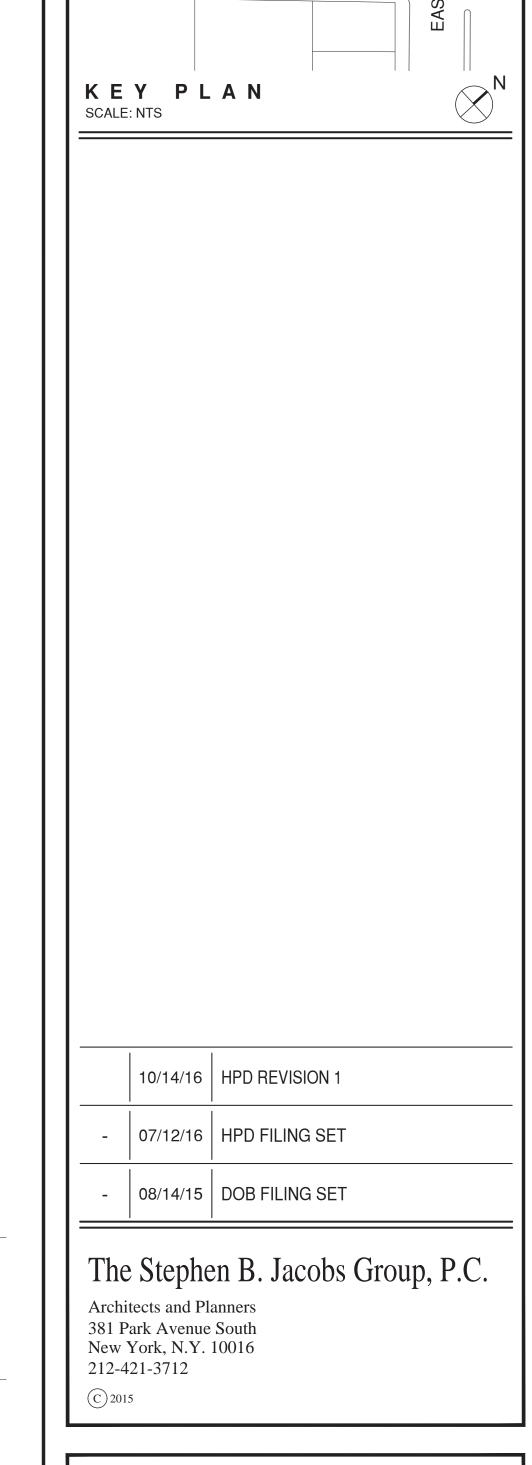
DOB# 121189711

255 EAST HOUSTON ST. MANHATTAN, N.Y. 10002

Drawing Title: HOUSTON WING ELEVATIONS





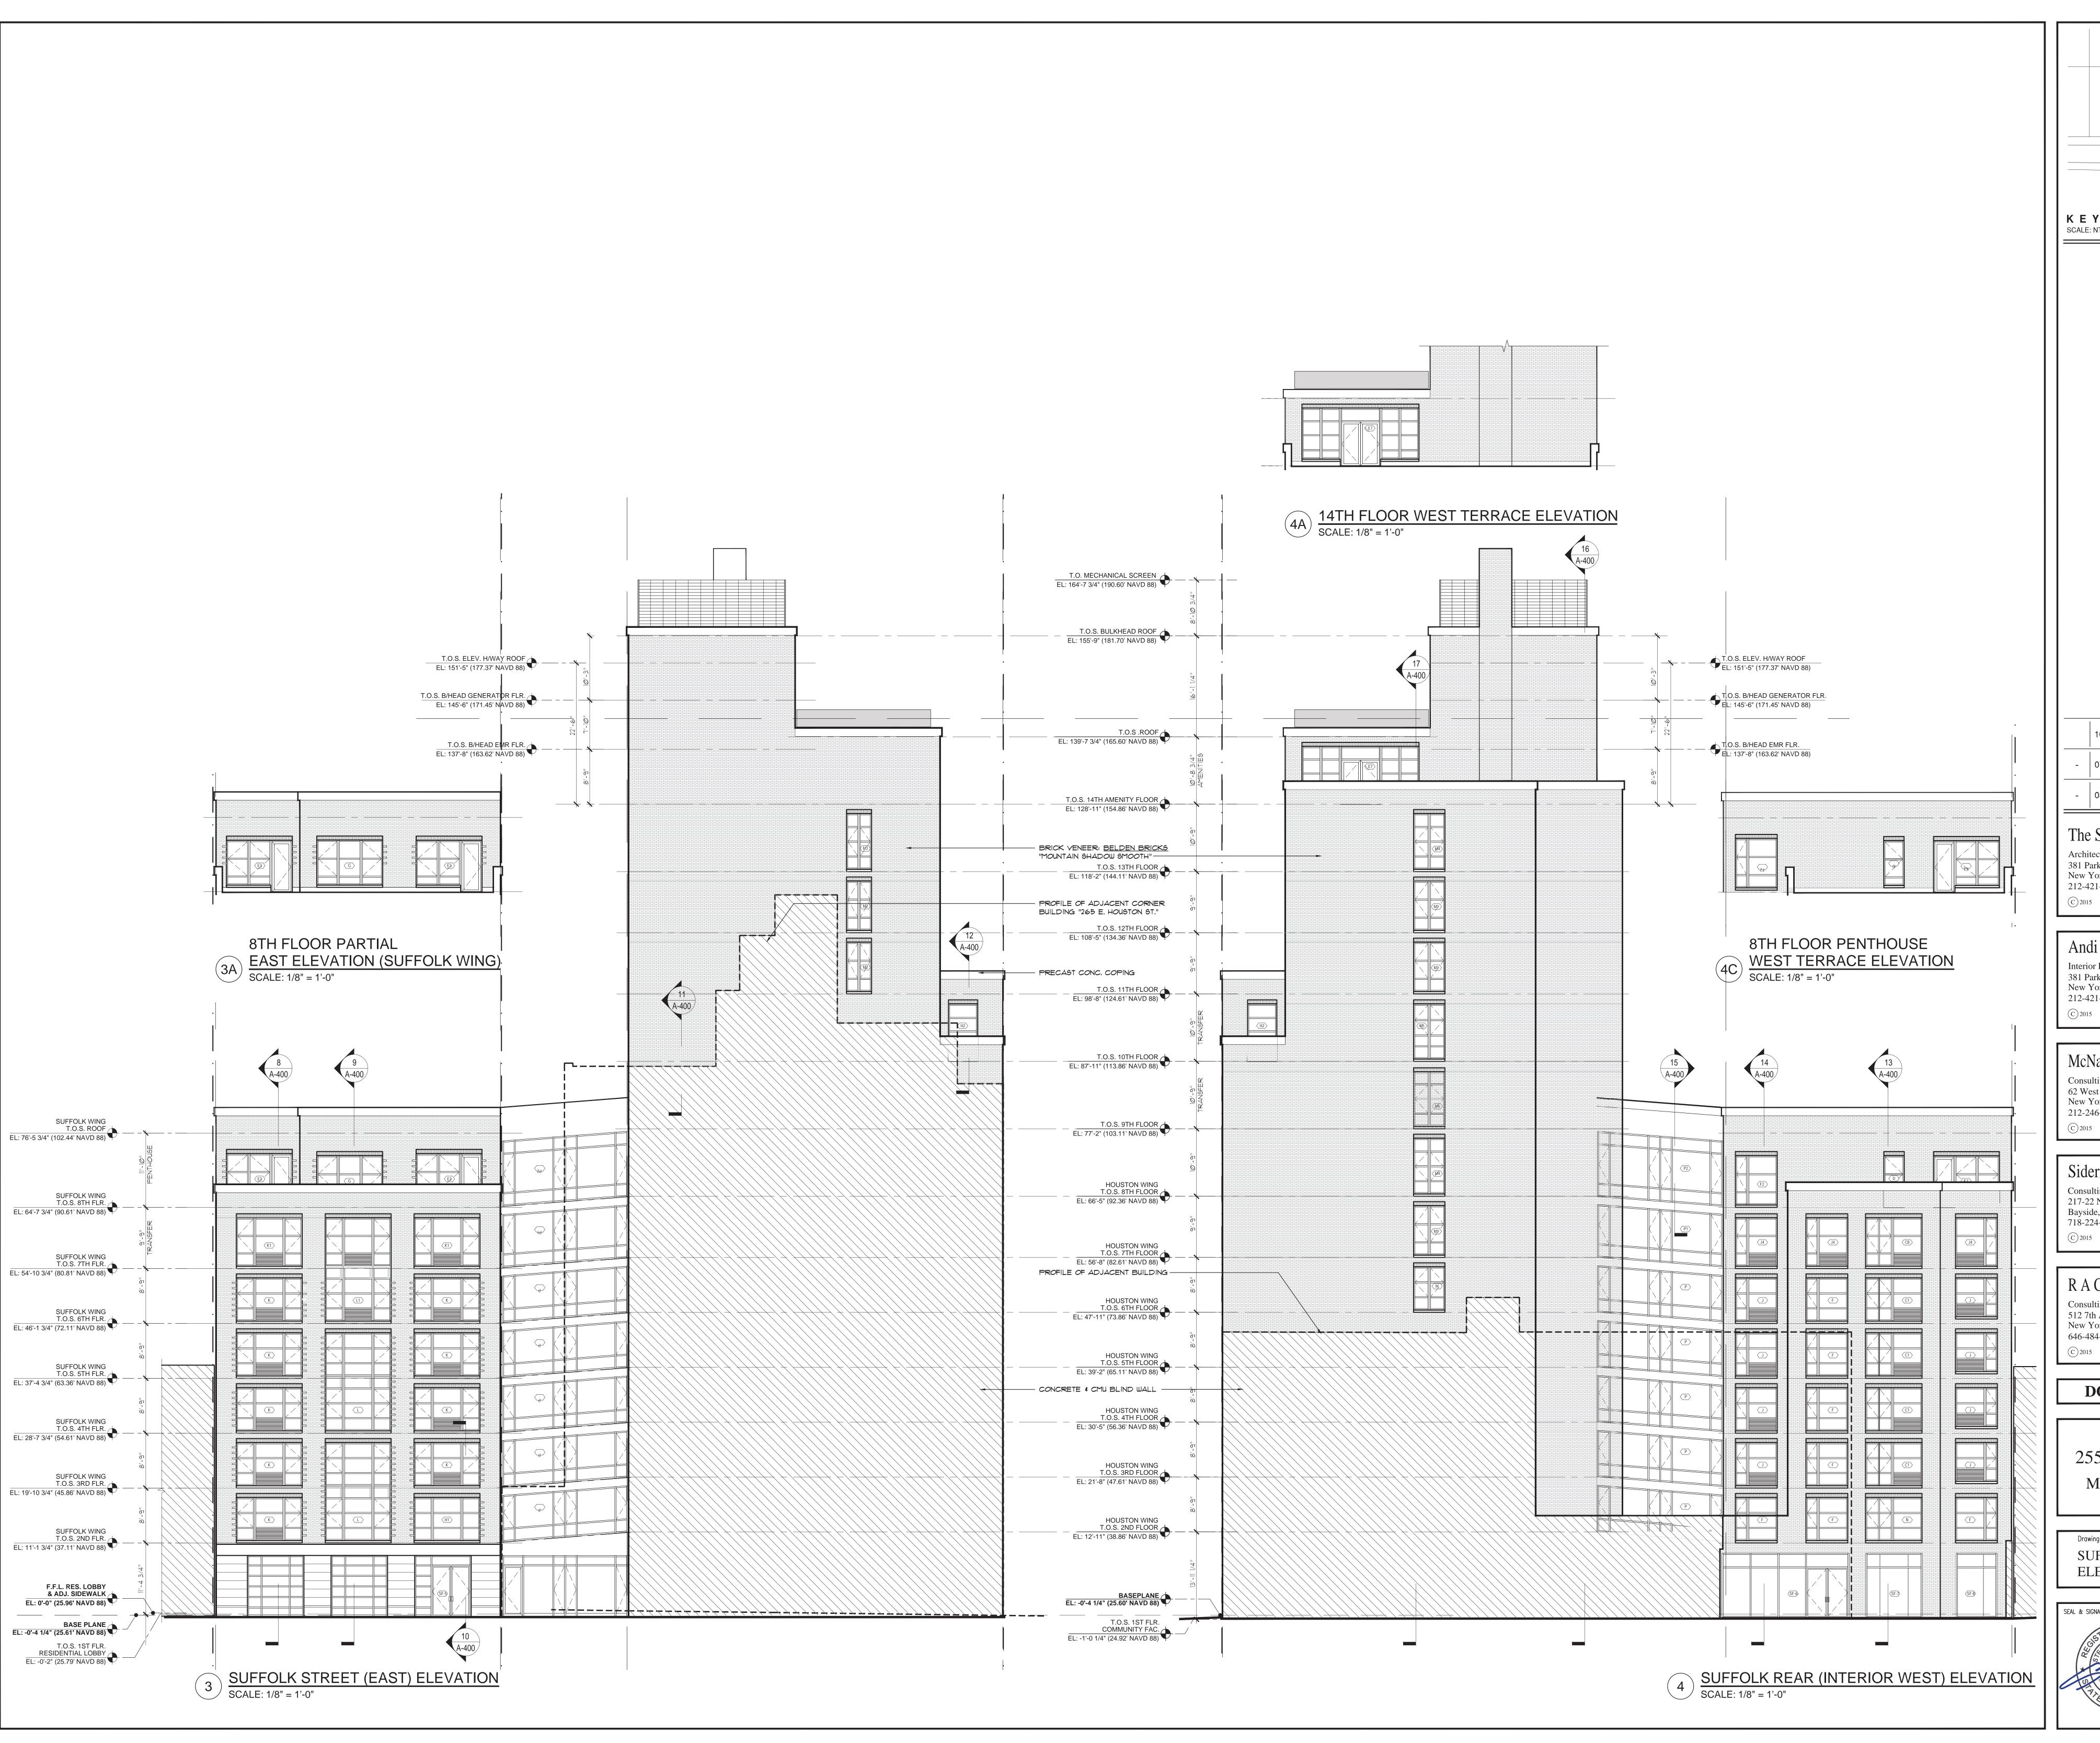

SUFFOLK STREET

Andi Pepper Interior Design

Interior Designers
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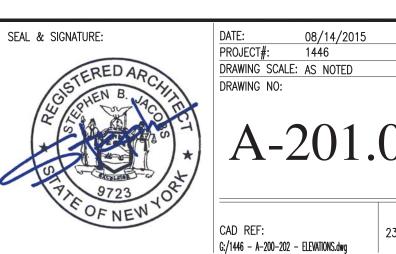
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646-484-3250

DOB# 121189711

255 EAST HOUSTON ST.
MANHATTAN, N.Y. 10002

Drawing Title:
SUFFOLK WING
ELEVATIONS



LOCATIO	ON T	AREA DESIGNATION	F	FLOOR	BASE	W	ALL	CEI	LING		REMARKS
			SUBSTRATE	FINISH	MATERIAL	SUBSTRATE	FINISH	SUBSTRATE	FINISH	HGT TO FIN. CL'G	
		STAIRS A & B	CONCRETE	PT/SEALER	-	CONC/CMU	PT/SEALER	CONCRETE	PT		
		PUBLIC CORRIDOR	CONCRETE			CONC/CMU		CONCRETE			
		LAUNDRY ROOM	CONCRETE	ст	ст	GWB	CT/PT	GWB	PŤ		
<u>~</u>		COMPACTOR ROOM	CONCRETE	PT/SEALER	-	CONC/CMU	PT/GEALER	CONCRETE	PT		
CELLAF		SUPER'S SHOP	CONCRETE	PT/SEALER	VB	CONC/CMU	PT/SEALER	CONCRETE	PT		
CELLAR	Ī	BIKE ROOM	CONCRETE	PT/SEALER	-	CONC/CMU	PT/GEALER	CONCRETE	PT		
		SERVICE CORRDIOR	CONCRETE	PT/SEALER	-	CONC/CMU	PT/6EALER	CONCRETE	PŤ		
	ŀ	ME.Rs	CONCRETE	PT/6EALER	-	CONC/CMU	PT/SEALER	CONCRETE	PT		ELEC, TELECOMS, GAS , BOILER WATER-FIRE PUMP & ATS RMS.
	ŀ	114.0	CONONLIE	T TOLALLIN		SONO/OF IG	1 1/01/11	CONCINE			WATER THE PARTY AND PARTY.
		0±4100 4 4 0	CONCOUNT	DT/CE ALED		COMO (Chill		CONCOLLE	D.T.		
	ŀ	STAIRS A & B	CONCRETE	PT/SEALER	-	CONC/CMU	PT/SEALER	CONCRETE	PT		
	ŀ	LOBBY	CONCRETE		-	CONC/CMU/GWB		CONC/SUSP GWB	PT.		
	ŀ	PUBLIC CORRIDOR	CONCRETE			CONC/CMU/GWB		GWB			
	-	BATHROOM	CONCRETE			CONC/CMU/GWB		CONC/SUSP GWB			
Ř	-	MAILROOM	CONCRETE			CONC/CMU/GWB		CONC/SUSP GWB			
FIRST FLOOR	-	AMENITY SPACE	CONCRETE			CONC/CMU/GWB		CONC/SUSP GWB			
STF	-	GARAGE	CONCRETE	PT/SEALER	-	CONC/CMU/GWB	PT.	CONC/SUSP GWB			
FIR\$		STORAGE	CONCRETE			CONC/CMU/GWB		CONC/SUSP GWB			
		SERVICE ENTRY	CONCRETE			CONC/CMU/GWB		CONC/SUSP GWB			
		SERVICE VESTIBULE	CONCRETE			CONC/CMU/GWB		CONC/SUSP GWB			
		PACKAGE ROOM	CONCRETE			CONC/CMU/GWB		CONC/SUSP GWB			
		JANITOR'S CLOSET	CONCRETE		-	CONC/CMU/GWB		CONC/SUSP GWB			
		LIVING ROOM	CONCRETE	WF	WD	GWB	PT	CONC/SUSP GWB	PT		
	TS	KITCHEN	CONCRETE	ст	WD	WR GWB	CT/PT	CONC/SUSP GWB	PT		
	AL UNITS	BEDROOM	CONCRETE	WF	WD	GWB	PT	CONC/SUSP GWB	PT		
SIDENTIAI 2 TO 13	RESIDENTIA	BATHROOM	CONCRETE	СТ	СТ	WR GWB/TBB	CT/PT	CONC/SUSP GWB	PT		
SIDE 2 TC	RES	CL0 9 ET	CONCRETE	WF	WD	GUB	PT	CONC/SUSP GWB	PŤ		
RE ORS	ŀ	WASHER/DRYER CLOSET	CONCRETE	СТ	СТ	GWB	PT	CONC	PT		
TYPICAL RES FLOORS	ŀ										
	\dashv	CTAIDC A A D	CONCRETE	PT/6EALER		CONC (CMI)	DT/GEALED	CONCRETE	DT.		
	Z	STAIRS A & B	CONCRETE		-	CONC/CMU	PT/SEALER	CONCRETE	PT		
	COMMON	RUBBISH ROOM	CONCRETE	СТ	СТ	GWB	CT	CONCRETE	PŤ		
		PUBLIC CORRIDOR	CONCRETE			CONC/CMU/GWB		GWB			
1 I	-	STAIRS A & B	CONCRETE	PT/SEALER	-	CONC/CMU	PT/SEALER	CONCRETE	PT		
<u>ج</u>	- 1	RUBBISH ROOM	CONCRETE	СТ	СТ	GWB	СТ	CONCRETE	PT		
LOOR	¥		CONCRETE			CONC/CMU/GWB		GWB			
TH FLOOR	AMENITY	PUBLIC CORRIDOR					1				I
14TH FLOOR	AMENITY	PUBLIC CORRIDOR AMENITY SPACE	CONCRETE			CONC/CMU/GWB		GWB			
4TH	AMENITY		CONCRETE			CONC/CMU/GWB		GWB			
14TH	AMENITY		CONCRETE	PT/SEALER	-	CONC/CMU/GWB CONC/CMU	PT/SEALER	CONCRETE	PT		
14TH	AMENITY	AMENITY SPACE		PT/SEALER PT/SEALER	-		PT/SEALER PT/SEALER		PT PT		
4TH	AMENITY	AMENITY SPACE STAIRS A	CONCRETE			CONC/CMU		CONCRETE			

ARCH. FINISHES ABBREVIATIONS:

			,
ACT	ACOUSTICAL CEILING TILE	PT	PAINT
BA	BATHROOM ACCESSORIES	SGFT	STRUCTURALLY GLAZED FACING TILE
BR CA	BRICK CABINET	ST	STONE
CBB	CEMENT BACKER BOARD	SUSP	SUSPENDED
CF	CONCRETE EL OOR	TBB	TILE BACKER BOARD

CF CONCRETE FLOOR CMU CONCRETE MASONRY UNIT WC WALL COVERING WD WOOD CONC CONCRETE WF WOOD FLOORING CPT CARPET CT TILE (CERAMIC U.O.N.)

WR WATER RESISTANT VCT VINYL COMPOSITION TILE EQUAL

NOTES:

1.) EXPOSED CIRCULAR CONCRETE COLUMNS WILL 4.) PROVIDE SUPPLEMENTAL MOUNTING PLATES, ZED BE FINISHED WITH COVER COAT AND PAINT BLOCKING, FRAMING, ETC, REQUIRED FOR RECESSED MOUNTED OR WALL MOUNTED 2.) PROVIDE FLEXIBLE MOLDINGS POLY RESIN BASE EQUIPMENT AND FIXTURES AT CIRCULAR COLUMNS BY DYKES OR APPROVED EQUAL TO MATCH APARTMENT BASE 6.) APPLY PENETRATING SEALANT AT ALL SUBGRADE AND/OR EXPOSED CONC. FLOOR & 3.) EXPOSED SPRINKLER LINES SHALL BE PAINTED FOUNDATION WALLS PRIOR TO FINISH

5.) PROVIDE ALL SPECIFIED ITEMS OR AN APPROVED

INSTALLATION. 7.) PROV. BID ALTERNATE FOR CERAMIC TILE I.L.O. WOOD FLOORING @ ALL RESIDENTIAL CORRIDORS

FINISH SCHEDULE NOTES:

GL GLASS


GWB GYPSUM WALL BOARD

- 1. BC 803.1 FLAME SPREAD & SMOKE DEVELOPMENT OF INTERIOR FINISHES ALL STAIRS, CORRIDORS & EGRESS PASSAGEWAYS TO BE FINISHED IN MATERIALS OF CLASS B OR BETTER AS PER BC 803.5.
- 2. <u>BC 803.1 FLAME SPREAD & SMOKE DEVELOPMENT OF INTERIOR FINISHES</u> -ALL ROOMS & ENCLOSED SPACES TO BE FINISHED IN MATERIALS OF CLASS B OR BETTER AS PER TABLE 803.5.

				TYPICAL A	APPLIANCES			
TAG	ITEM	MANUFACTURER	MODEL	FINISH	DIMENSIONS	LOCATION	REMARKS	UNIT/TYPE
AP-10	18" DISHWASHER	GE	PDW1860NSS	STAINLESS STEEL	32"H X 24"D X 18"W			
AP-11	24" DISHWASHER	GE	GLDT69DSS	STAINLESS STEEL	31-11/32"H X 24"D X 24"W			
AP-20	24" FRIDGE	LG	LBN10551PS	STAINLESS STEEL	68 1/2"H X 25-3/8"D X 23-3/8"W			
AP-21	30" FRIDGE	SUMMIT	FFBF285SSX	STAINLESS STEEL	72 1/4"H X 24 3/7"D X 27 3/4" W			
AP-22	36" FRIDGE	GE	PZS22MSKSS	STAINLESS STEEL	69 1-4"H x 30 3/4" D x 35 3/4"W			
AP-30	21" COOKTOP	GE	JP256BMBB	STAINLESS STEEL	3-3/4"H X 17 1/8"D X 21-1/2"W		ADA COMPLIANT	
AP-31	30" COOKTOP	GE	JP5030DJBB	STAINLESS STEEL	5-9/16"H X 20 7/8"D X 29-3/4"W			
AP-40	27" BUILT IN OVEN	GE	JK1000SFSS	STAINLESS STEEL	28-3/4"H X 26-5/8"D X 26-3/4"W			
AP-41	30" BUILT IN OVEN	GE	JTI000SFSS	STAINLESS STEEL	28 5/8"H X 26-3/4"D X 29-3/4"W			
AP-50	30" OTR MICROWAVE	GE	PVM9179SFSS	STAINLESS STEEL	16-1/4"H X 15-1/2"D X 29-7/8"W			
AP-60	DRYER	GE	DCVH480EKWW	WHITE	33-3/8"H X 25-11/16"D X 23-1/2"W		INCLUDE STACKING KIT	
AP-61	WASHER	GE	GFW1200HWW	WHITE	39-7/8"H X 32"D X 27"W		INCLUDE STACKING KIT	
				UFAS A	PPLIANCES			
TAG	ITEM	MANUFACTURER	MODEL	FINISH	DIMENSIONS	LOCATION	REMARKS	UNIT/TYPE
AP-20A	24" FRIDGE	FRIGIDAIRE	FFTR122Q	WHITE	59-7/8"H X 28-7/8"D X 24"W	UFAS APARTMENTS	3" AIR CLEARANCE REQ'D ON ALL SIDES. ALLOW 50-1/2"D FOR DOOR TO OPEN	
AP-21A	30" FRIDGE	FRIGIDAIRE	FFHI1831Q	STAINLESS STEEL	66-1/8"H X 29-7/8"D X 30"W	UFAS APARTMENTS	ALLOW FOR SPACE FOR HANDLE WHEN INSTALLED NEXT TO WALL. ALLOW 58-1/2"D FOR DOOR TO OPEN	
AP-30A	24" COOKTOP					UFAS APARTMENTS		
AP-50A	24" RANGE HOOD	GE	JV248P	STAINLESS STEEL	5-1/2"H X 17-1/2"D X 23-7/8"W	UFAS APARTMENTS	RECIRCULATING	
AP-51A	30" RANGE HOOD	GE	JV348L	STAINLESS STEEL	5-1/2"H X 17-1/2"D X 29-7/8"W	UFAS APARTMENTS	RECIRCULATING	
AP-52A	24" COUNTERTOP MICROWAVE	GE	PEM31SFSS	STAINLESS STEEL	12-1/8"H X 12-7/8"D X 24"W	UFAS APARTMENTS		
AP-60A	WASHER/DRYER	LG	WM3997HWA	WHITE	38-11/16"H X 29-3/4"D X 27"W	UFAS APARTMENTS	INCLUDE LAUNDRY PEDESTAL WDP4W	

				PLUMBING	FIXTURES			
TAG	ITEM	MANUFACTURER	MODEL	FINISH	DIMENSIONS	LOCATION	REMARKS	UNIT/TYPE
PF-01	KITCHEN FAUCET	MOEN	PDW1860NSS / 90 DEGREE	CHROME	12-3/8"H X 9-13/16"D X 2-1/2"W	KITCHEN	ADA WITH LEVER HANDLE	
PF-02	KITCHEN SINK	KOHLER	K-3894-4 /VAULT	STAINLESS STEEL	11-5/8"H X 22"D X 25"W	KITCHEN	ADA COMPLIANT	
PF-03	KITCHEN SINK	MOEN	G18190	STAINLESS STEEL	10"H X 18"D X 23"W	KITCHEN		
PF-04	BATHROOM FAUCET	MOEN	TS6720 / 90 DEGREE	CHROME	4"H X 4-5/8"D X 14"W	BATHROOM	ADA WITH LEVER HANDLE	
PF-05	BATHROOM SINK	тото	LT156 / VERNICA	WHITE	6-5/8"H X 14-1/8"D X 2 1/2"W	BATHROOM	ADA COMPLIANT	
PF-06	WALL MOUNT BATHROOM SINK	KOHLER	K-2053 / SOHO	WHITE	7"H X 18"D X 16 1/4"W	BATHROOM	ADA COMPLIANT	
PF-07	SINK TRAP	KOHLER	K-8998		4-3/8"H X 11-3/4"D X 1-1/4"W	BATHROOM	ADA COMPLIANT	
PF-08	DIVERTER	MOEN		CHROME				
PF-09	TUB/SHOWER TRIM	MOEN	TS2713 / 90 DEGREE	CHROME	8-3/8" EXT. x 6-3/16W	BATHROOM	ADA WITH LEVER HANDLE	
PF-10	SHOWER PAN	TILE-REDI	PAN: 3248CBF-PVC DRAIN: 1PSQ-PC	PAN: WHITE DRAIN: POLISHED CHROME	48" X 32"	BATHROOM	INCLUDE DRAIN AND COVER	
PF-11	HANDSHOWER	MOEN	S3879EP / 90 DEGREE	CHROME	30-5/8"H X 2-1/8"W	BATHROOM	INCLUDE HOSE ATTACHMENT	
PF-12	TOILET	тото	CST416M / ACQUIA II	WHITE	30-1/4"H X 27-1/2"D X 14-1/4"W	BATHROOM	INCLUDE SOFT CLOSE SEAT SS144. CONTRACTOR TO SPECIFY FLUSH HANDLE LOCATION TO BE LOCATED AS PER ADA REQUIREMENTS	
PF-13	TOILET BOWL	KOHLER	K-4302 / HIGHCREST	WHITE	16-1/2"H X 26"D X 14 1/2"W	BATHROOM	TOILET BOWL ONLY	
PF-14	5' TUB	KOHLER	K-875 / BELLWETHER	WHITE	15-1/2"H X 32"D X 60"W	BATHROOM	CONTRACTOR TO SPECIFY DRAIN LOCATION. REQUIRES DRAIN	
PF-15	BATHROOM FAUCET	AMERICAN STANDARD	2590.801 STUDIO	CHROME	7"EXT X 7"H	BATHROOM	ADA COMPLIANT	
PF-16	FLUSHOMETER	KOHLER	K-13516-RF	CHROME		BATHROOM	ADA COMPLIANT	
			PL	UMBING FIXT	TURES - UFAS	6		
TAG	ITEM	MANUFACTURER	MODEL	FINISH	DIMENSIONS	LOCATION	REMARKS	UNIT/TYPE
PF-09A	SHOWER TRIM	MOEN	TS2711	CHROME	6-7/16" SQ	BATHROOM	PROVIDE ROUGH-IN	
PF-09B	SHOWER DIVERTER	MOEN	TS4172-3372	CHROME	4" SQ	BATHROOM	PROVIDE ROUGH-IN, 3 WAY TRANSFER VALVE	
PF-09C	SHOWER HEAD AND ARM	MOEN	HEAD: S6340 ARM: S133	CHROME	6-3/16" HEAD 8-3/8" EXT.	BATHROOM	INCLUDE SHOWER HEAD AND ARM	
PF-10A	SHOWER PAN	TILE-REDI	RT-3060CBFC-PVC-SQPC	WHITE	30" X 6-" X 5-3/4"H	BATHROOM	INCLUDE POLISHED CHROME DESIGNER GRATE DRAIN	
PF-11A	HANDSHOWER	MOEN	HEAD: 9349EP15 DROP-ELL: A721 CRADLE: A755 HOSE: CL155748 VACUUM BREAKER: A714	CHROME	HANDSHOWER HEAD: 3-5/16" x 8-1/8" HOSE LENGTH: 59"	BATHROOM	INCLUDE HEAD, HOSE, HOSE DROP-ELL, HANDSHOWER CRADLE. INCLUDE ADA COMPLIANT PAUSE BUTTON.	

				ACCESS	ORIES			
TAG	ITEM	MANUFACTURER	MODEL	FINISH	DIMENSIONS	LOCATION	REMARKS	UNIT/TYPE
BA-01	SHOWER ROD	MOEN	CSR21644CH	CHROME	3 1/4"H X 7 1/2"D X 72"W	BATHROOM	ADJUSTABLE TO 5' TUBS	
BA-02	TOWEL BAR	MOEN	YB8818/YB8824 / 90 DEGREE	CHROME	18" OR 24" X 2-1/2"EXT	BATHROOM	TBD 18" OR 24"	
BA-03	TOILET TISSUE HOLDER	MOEN	YB8808 / 90 DEGREE	CHROME	8-1/2"W X 1-1/2"H X 3"EXT	BATHROOM		
BA-04	ROBE HOOK	MOEN	YB8803	CHROME	1-1/2"H X 2-1/8"D X 1-3/8"W	BATHROOM		
BA-05	MEDICINE CABINET	RED STAR DESIGN	CUSTOM		SEE DRAWINGS	BATHROOM	INTEGRATED LIGHT STRIPS	
BA-06	ROBE HOOK	BOBRICK	B-212	ALUMNIUM	3-3/4"EXT X 2"H X 1-1/2"W	BATHROOM		
BA-07	TOILET TISSUE HOLDER	BOBRICK	B-685	STAINLESS STEEL	2"H X 4"D X 7-3/4"W	BATHROOM		
BA-08	PAPER TOWEL DISPENSER/ DISPOSAL	BOBRICK	B-369	STAINLESS STEEL	28"H X 4"D X 14"W	BATHROOM		
BA-09	ADA MIRROR	BOBRICK	B-293 2436	STAINLESS STEEL	4-3/8" EXT, 36"H X 24"W	BATHROOM		
BA-10	SOAP DISPENSER	BOBRICK	B-4112	STAINLESS STEEL	8-1/8"H X 3-5/16"D X 7"W	BATHROOM		
				HARDV	VARE			·
HW-01	DOOR HANDLE	MARKS USA	SF150	CHROME	5"L X 3"D	APARTMENTS		
HW-02	VANITY LEG	HAFELE	634.47.203	POLISHED CHROME	9-1/2"H x 6" x 1"D	BATHROOM VANITY		
HW-03	RECESSED DOOR PULL	RICHELIEU	616748160174	CHROME	1-9/16"W X 9/16"D X 6-17/32"L	BATHROOM VANITY		
HW-03A	TOUCH-TO-OPEN DOOR HARDWARE	BLUM	TIP-ON SYSTEM			ADA BATHROOM VANITY, ADA KITCHEN CABINETS		
HW-04	CABINET DOOR PULL	RICHELIEU	318912140	POLISHED CHROME	3/4" PANEL, 1-11/32"H X 27/32"TH X ADJUSTABLE LENGTH	KITCHEN CABINETS		

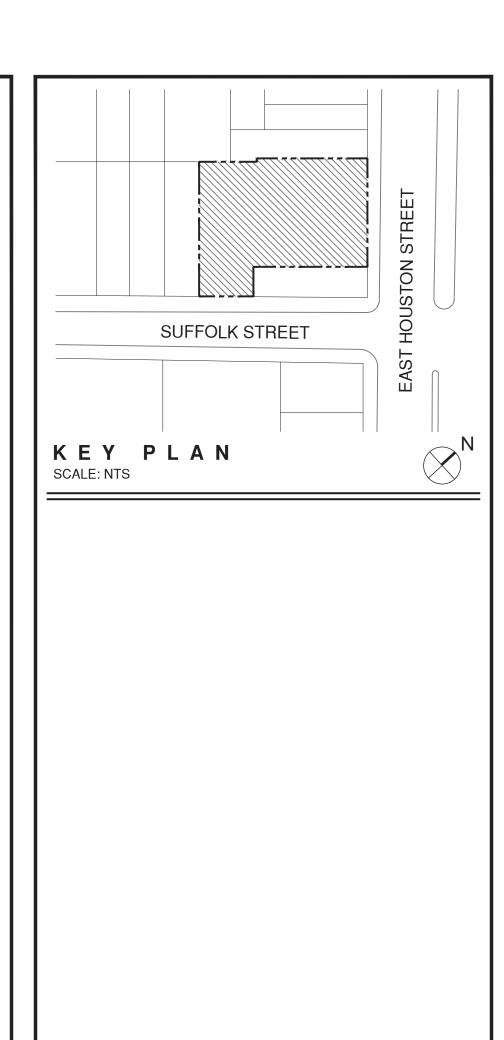

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- 08/14/15 DOB FILING SET

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Andi Pepper Interior Design

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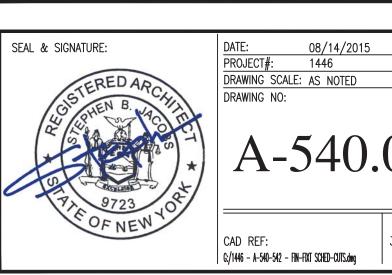
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33 OF 40


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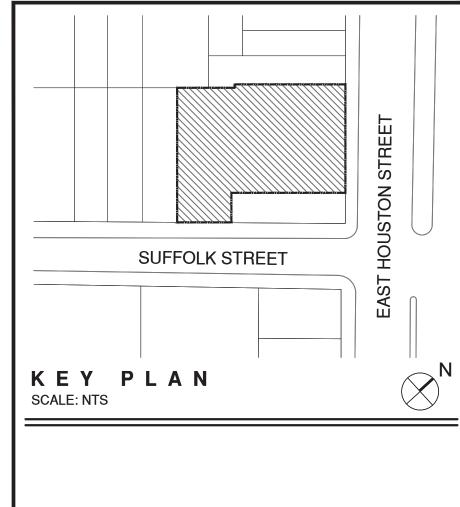
Drawing Title: FINISH, APPLIANCE & FIXTURE SCHEDULES



KITCHEN APPLIANCE, PLUMBING FIXTURE & ACCESSORIES, AND TYPE B ADAPTABILITY NOTES:

- 1) WHILE ALL MANUFACTURERS & MODEL NUMBERS ARE CORRECT AT DATE OF THIS FILING, PLEASE NOTE THAT THIS IS SUBJECT TO CHANGE AT THE TIME OF BUY-OUT DUE TO MANUFACTURER DISCONTINUING MODELS.
- 2) THE ABOVE NOTWITHSTANDING, OWNERSHIP RETAINS THE RIGHT TO SUBSTITUTE ANY KITCHEN APPLIANCE, PLUMBING FIXTURE OR ACCESSORY WITH AN EQUAL OR BETTER PRODUCT.
- 3) THE PRIMARY ACCESSIBILITY CODES IN EFFECT 2014 NYC BC CH. 11 / APP. P; ANSI A117.1-2003 (SAFE HARBOR); SECTION 504 OF THE REHABILITATION ACT OF 1973; FAIR HOUSING ACT 1991; AND UFAS 1994 GUIDELINES - ALL STATE THE NOTION OF ADAPTABILITY, WHEREIN BUILDING OWNERSHIP UNDERTAKES TO MAKE ALL NECESSARY MILLWORK ALTERATIONS & PROVIDE ALL NECESSARY KITCHEN APPLIANCE, PLUMBING FIXTURE & WASHER-DRYER SUBSTITUTIONS AS REQUIRED FOR FULL COMPLIANCY AT THE TIME A TENANT WITH PHYSICAL DISABILITIES TAKES OCCUPANCY OF THE UNIT, OR WITHIN 10 DAYS OF THE DATE THE REQUEST IS MADE BY A PERSON WITH PHYSICAL DISABILITIES, WHICHEVER IS LATER, AT OWNERSHIP'S



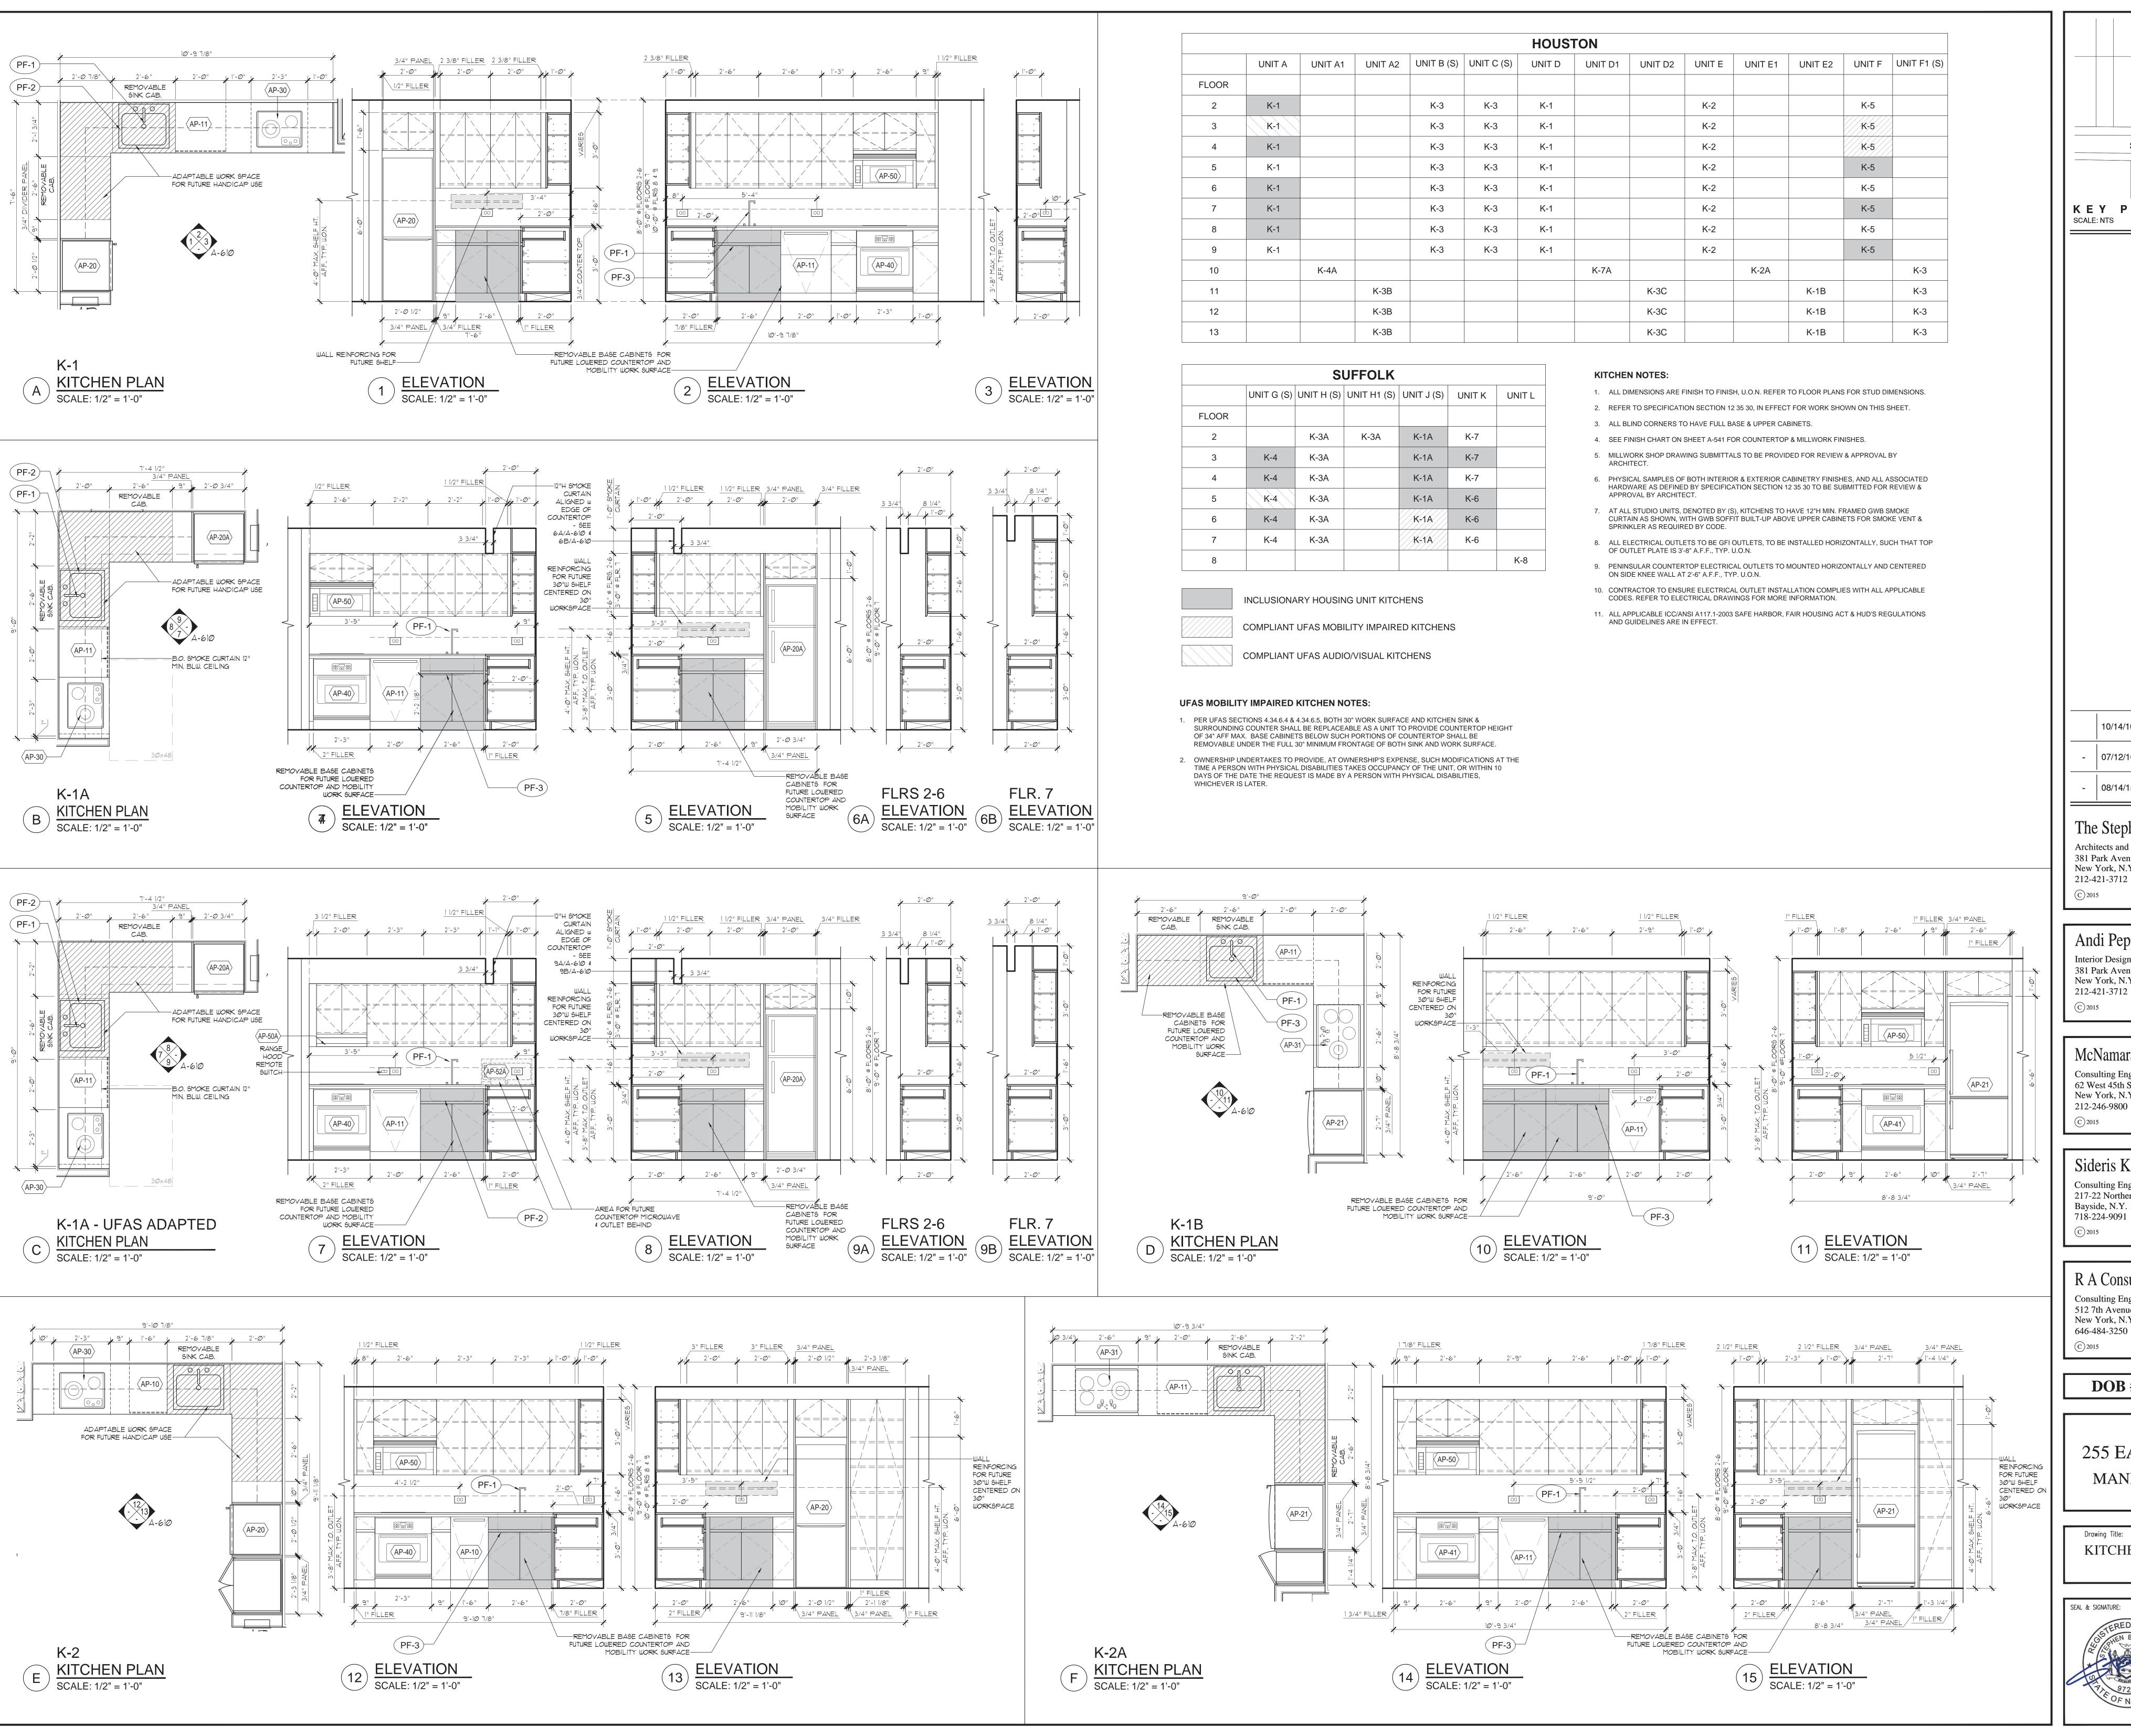

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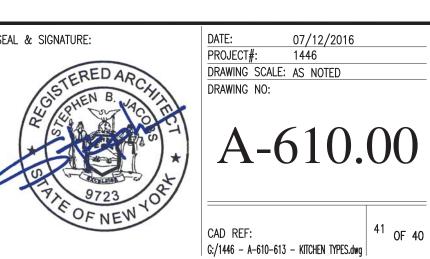
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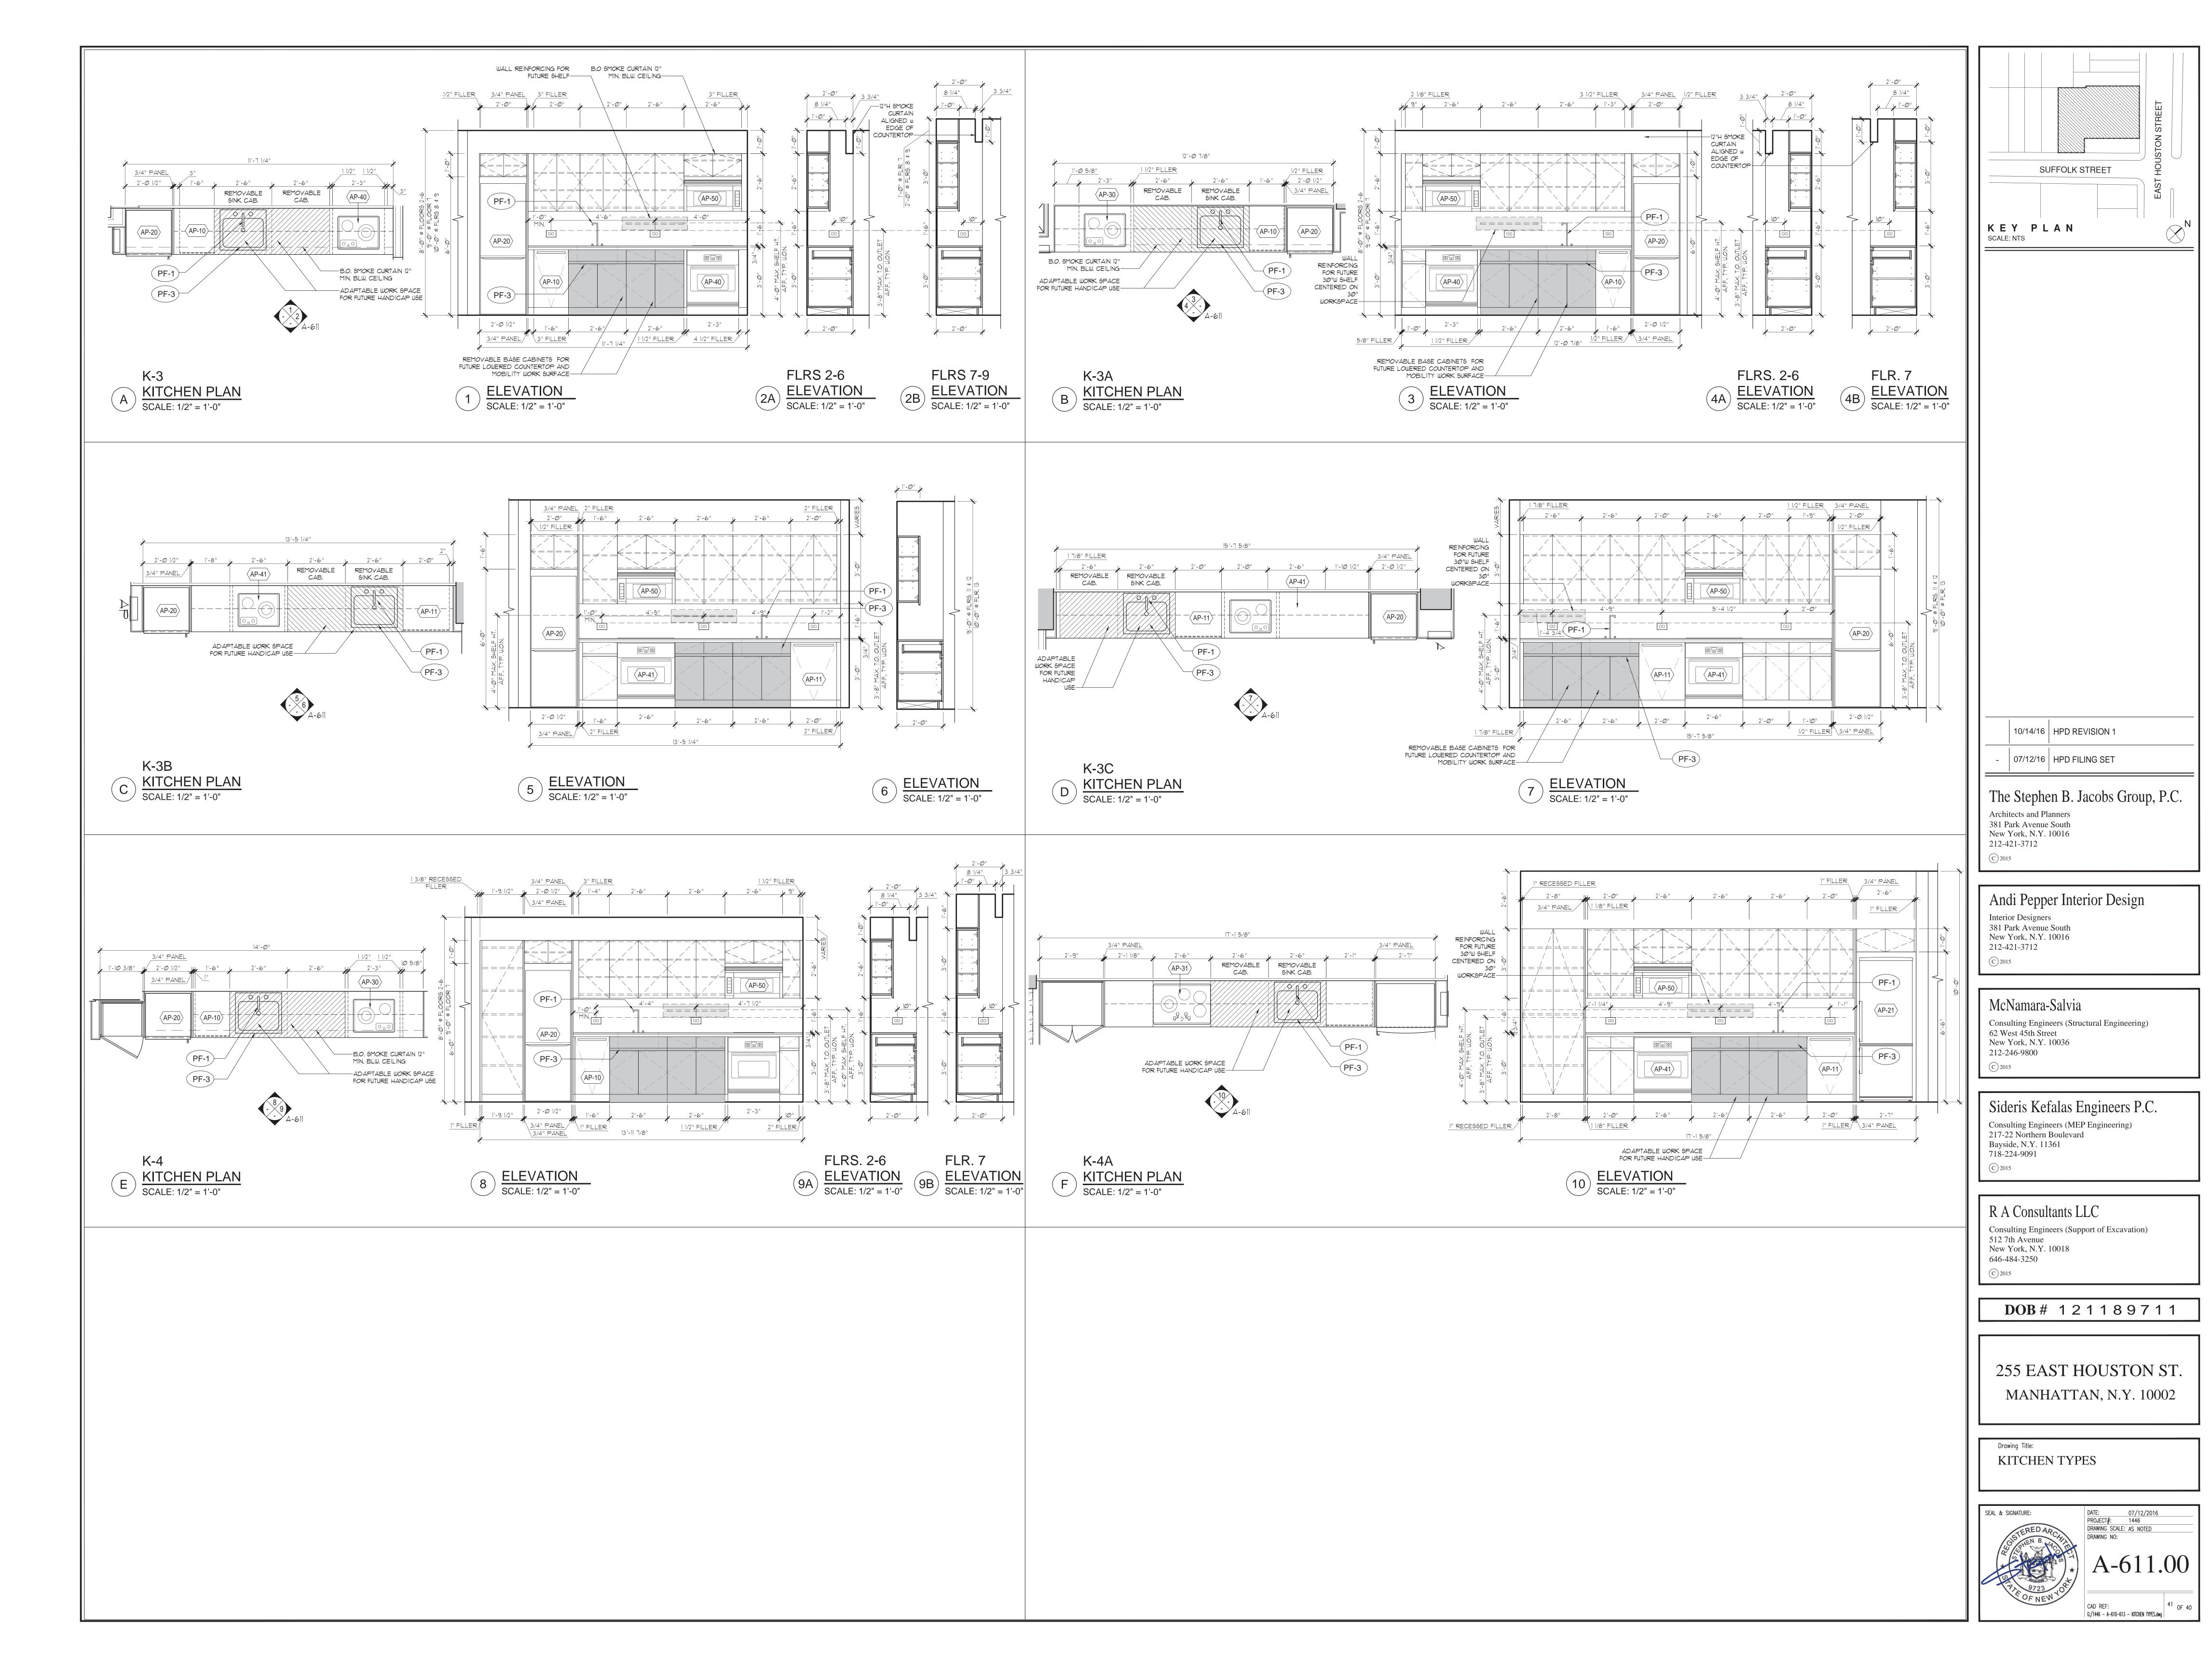
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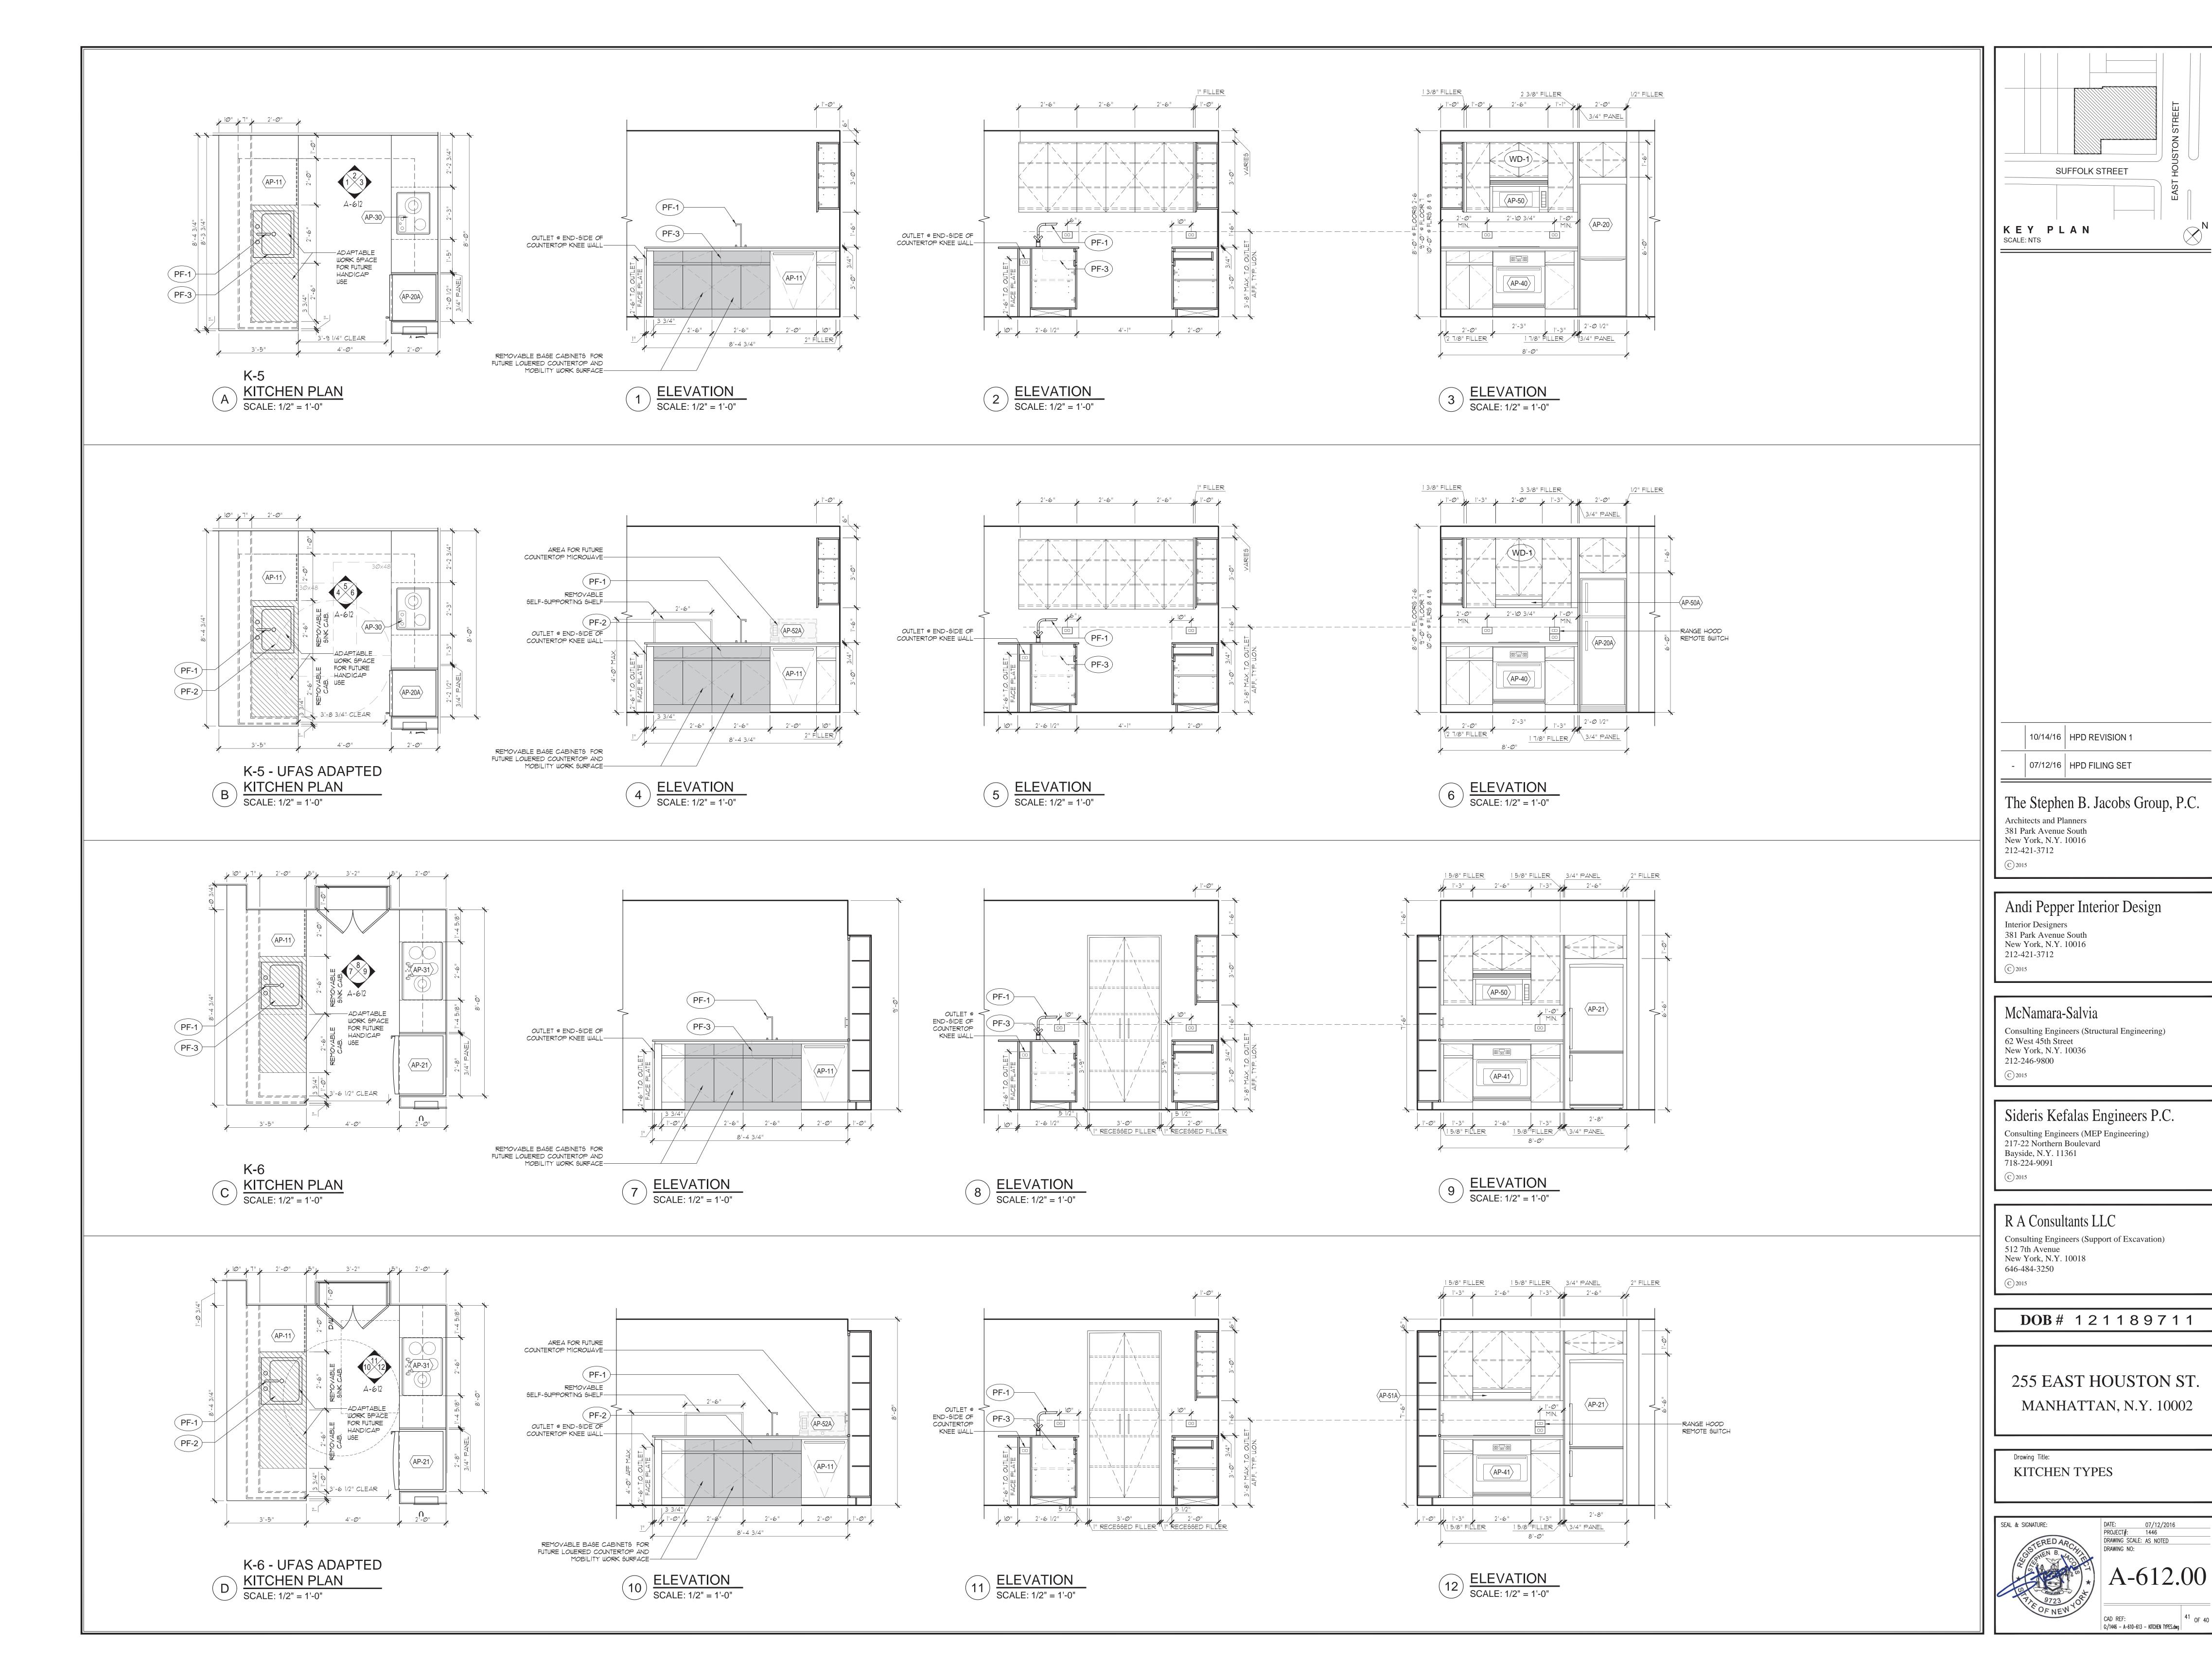
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Drawing Title: KITCHEN TYPES








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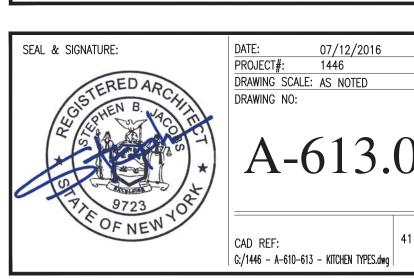
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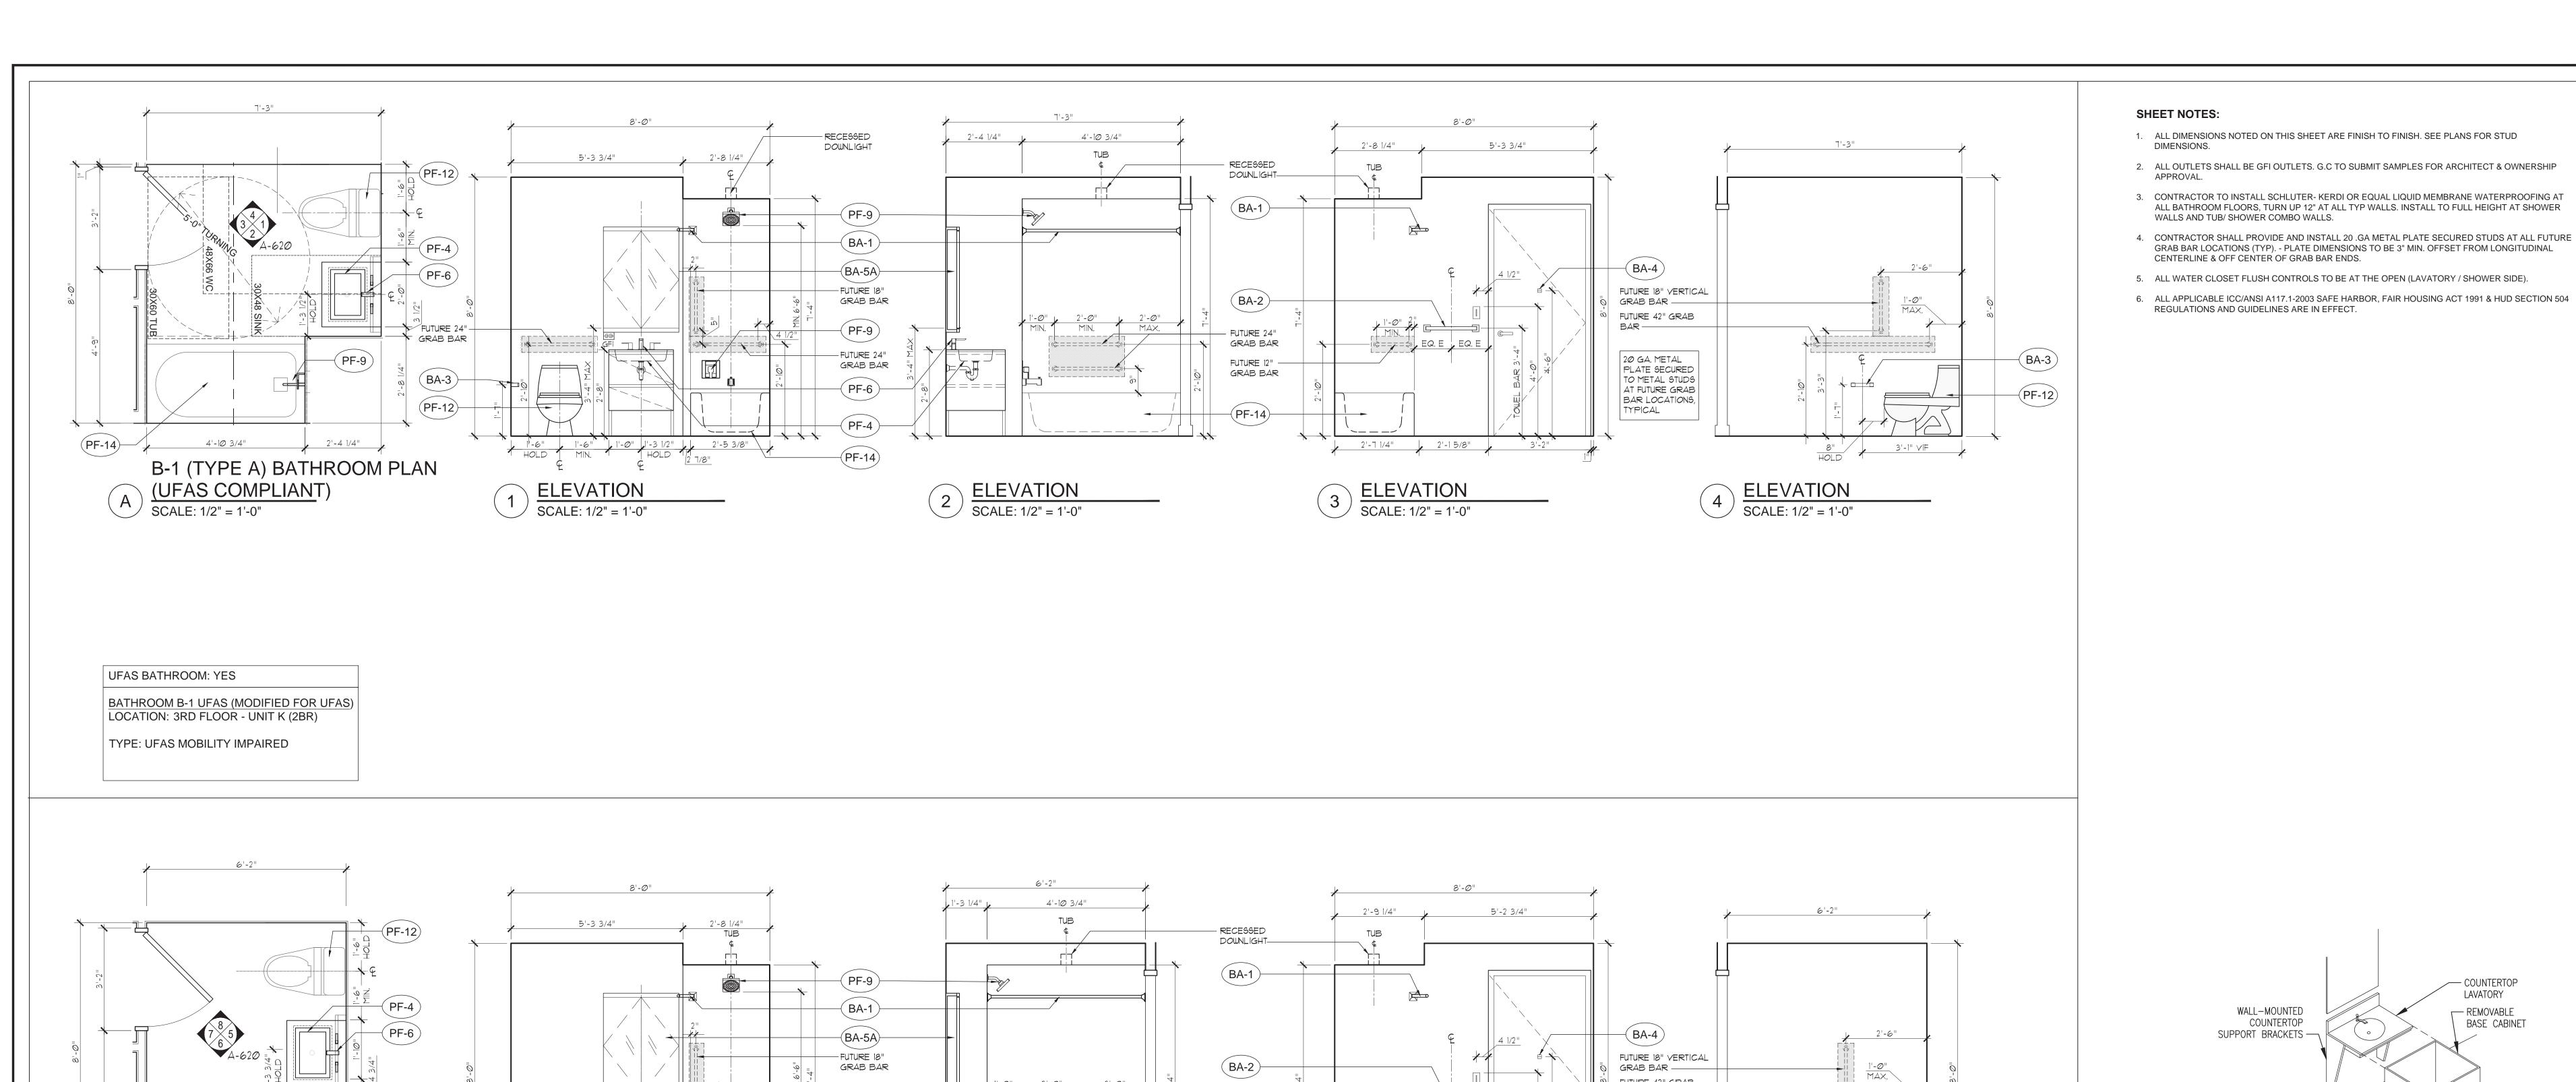
DOB# 121189711

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Drawing Title: KITCHEN TYPES

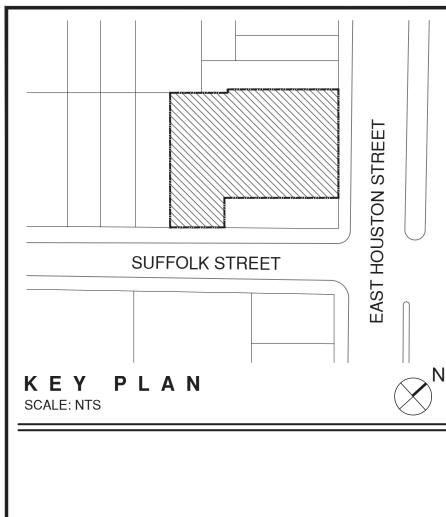

41 OF 40



- FUTURE 24"

GRAB BAR

FUTURE 12" -

GRAB BAR

PF-14

FUTURE 42" GRAB BAR —

20 GA. METAL PLATE SECURED TO METAL STUDS

AT FUTURE GRAB BAR LOCATIONS, TYPICAL

ELEVATION


SCALE: 1/2" = 1'-0"


2'-5 3/8" 2'-3 1/2" 3'-2"


7 ELEVATION
SCALE: 1/2" = 1'-0"

BA-3

(PF-12)

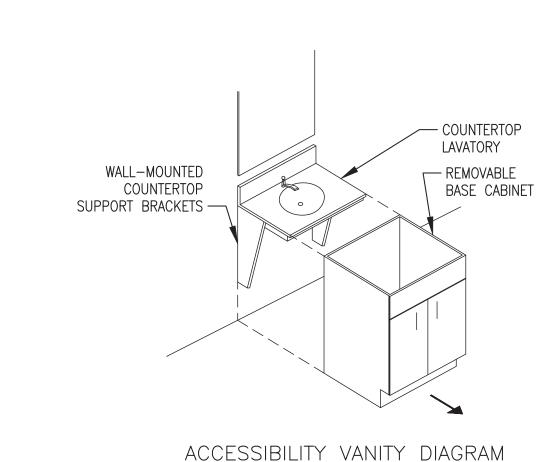

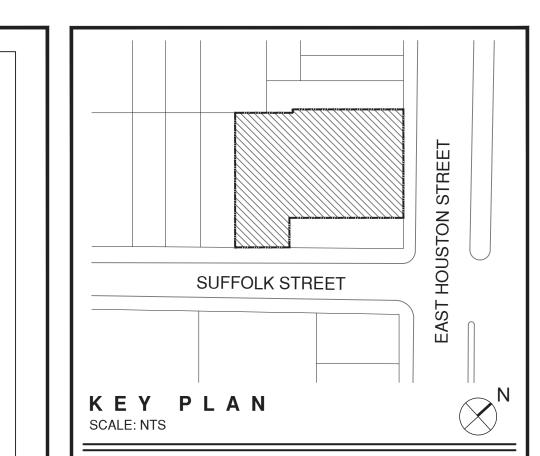

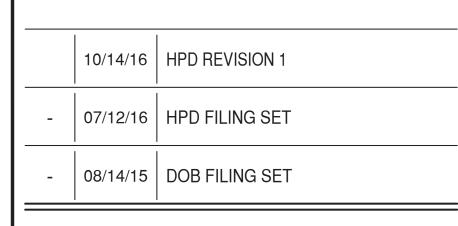

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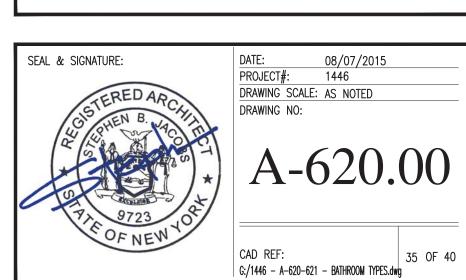
R A Consultants LLC


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DOB# 121189711

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Drawing Title: **BATHROOM TYPES**





6 ELEVATION
SCALE: 1/2" = 1'-0"

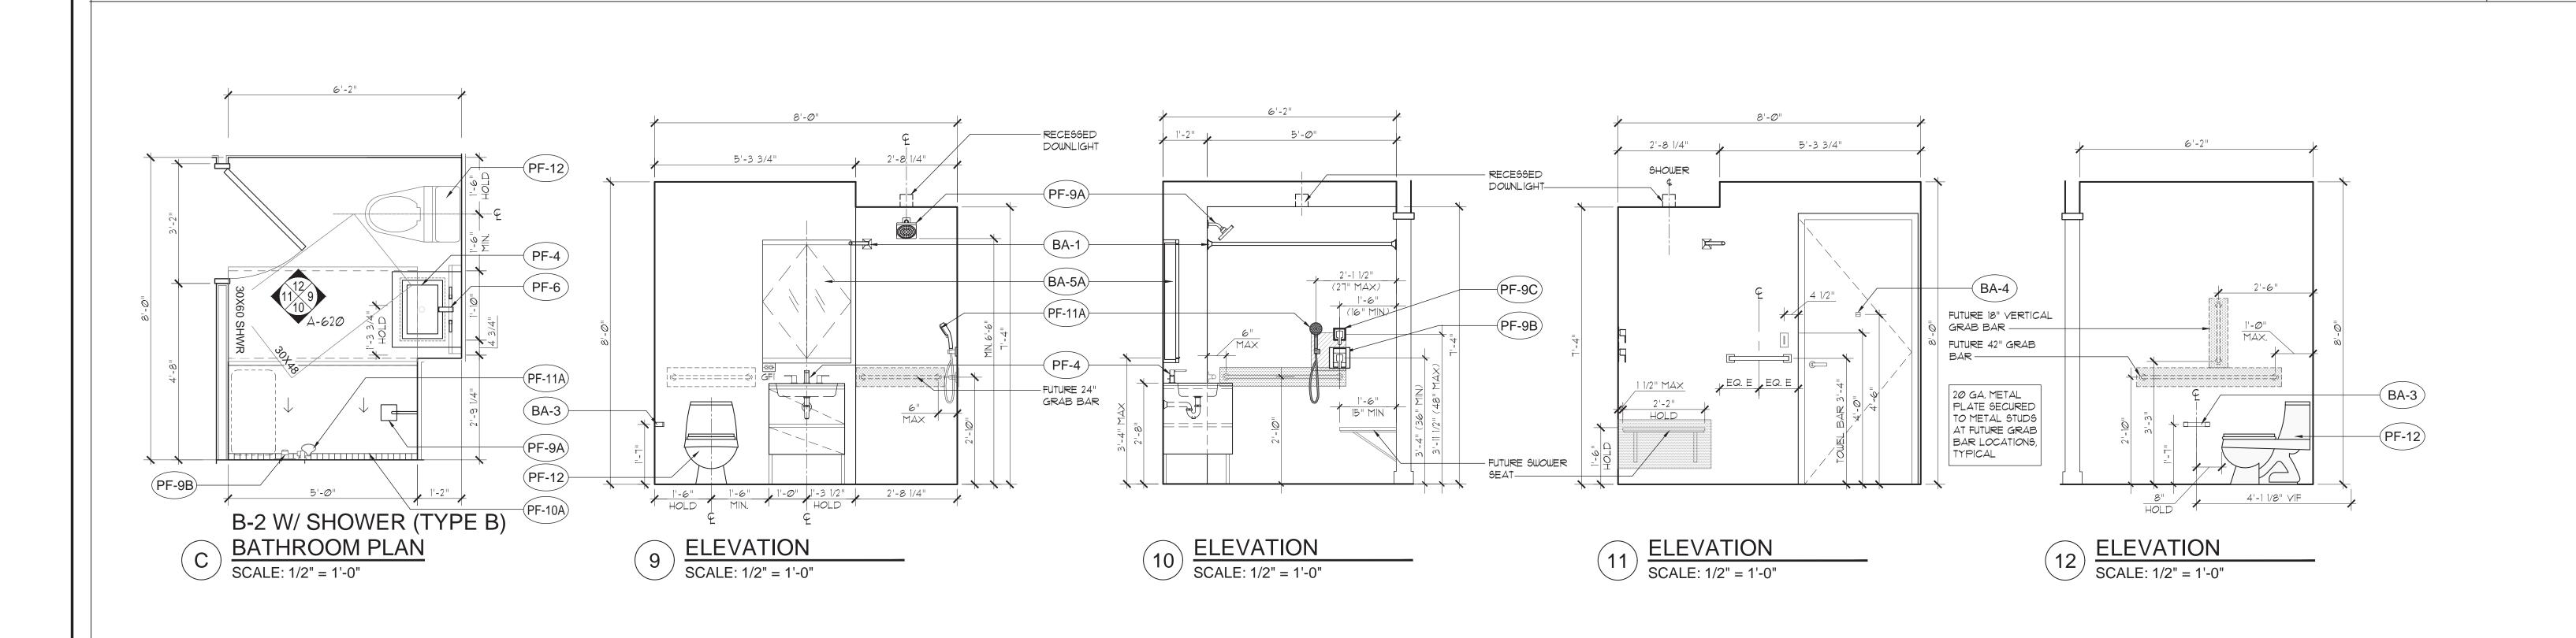PF-9

-FUTURE 24"

PF-6

GRAB BAR

FUTURE 24" — GRAB BAR

B-2 (TYPE B) BATHROOM PLAN

(UFÀS COMPLIANT)
SCALE: 1/2" = 1'-0"

BATHROOM B-2 UFAS (MODIFIED FOR UFAS) LOCATION: 3RD FLOOR - UNIT F (1BR)

TYPE: UFAS MOBILITY IMPAIRED

4TH FLOOR - UNIT F (1BR)


6TH FLOOR - UNIT J (STU)


7TH FLOOR - UNIT J (STU)


UFAS BATHROOM: YES


| 1'-6" | 1'-0" | 1'-3 1/2" | 2'-5 3/8" | HOLD | MIN. | HOLD | 2 1/8"


5 <u>ELEVATION</u> SCALE: 1/2" = 1'-0"

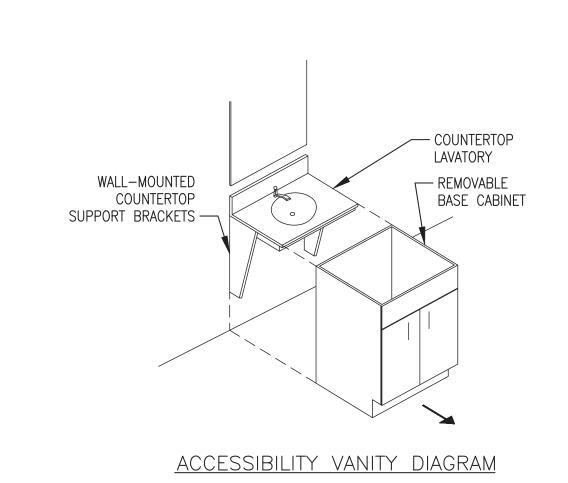

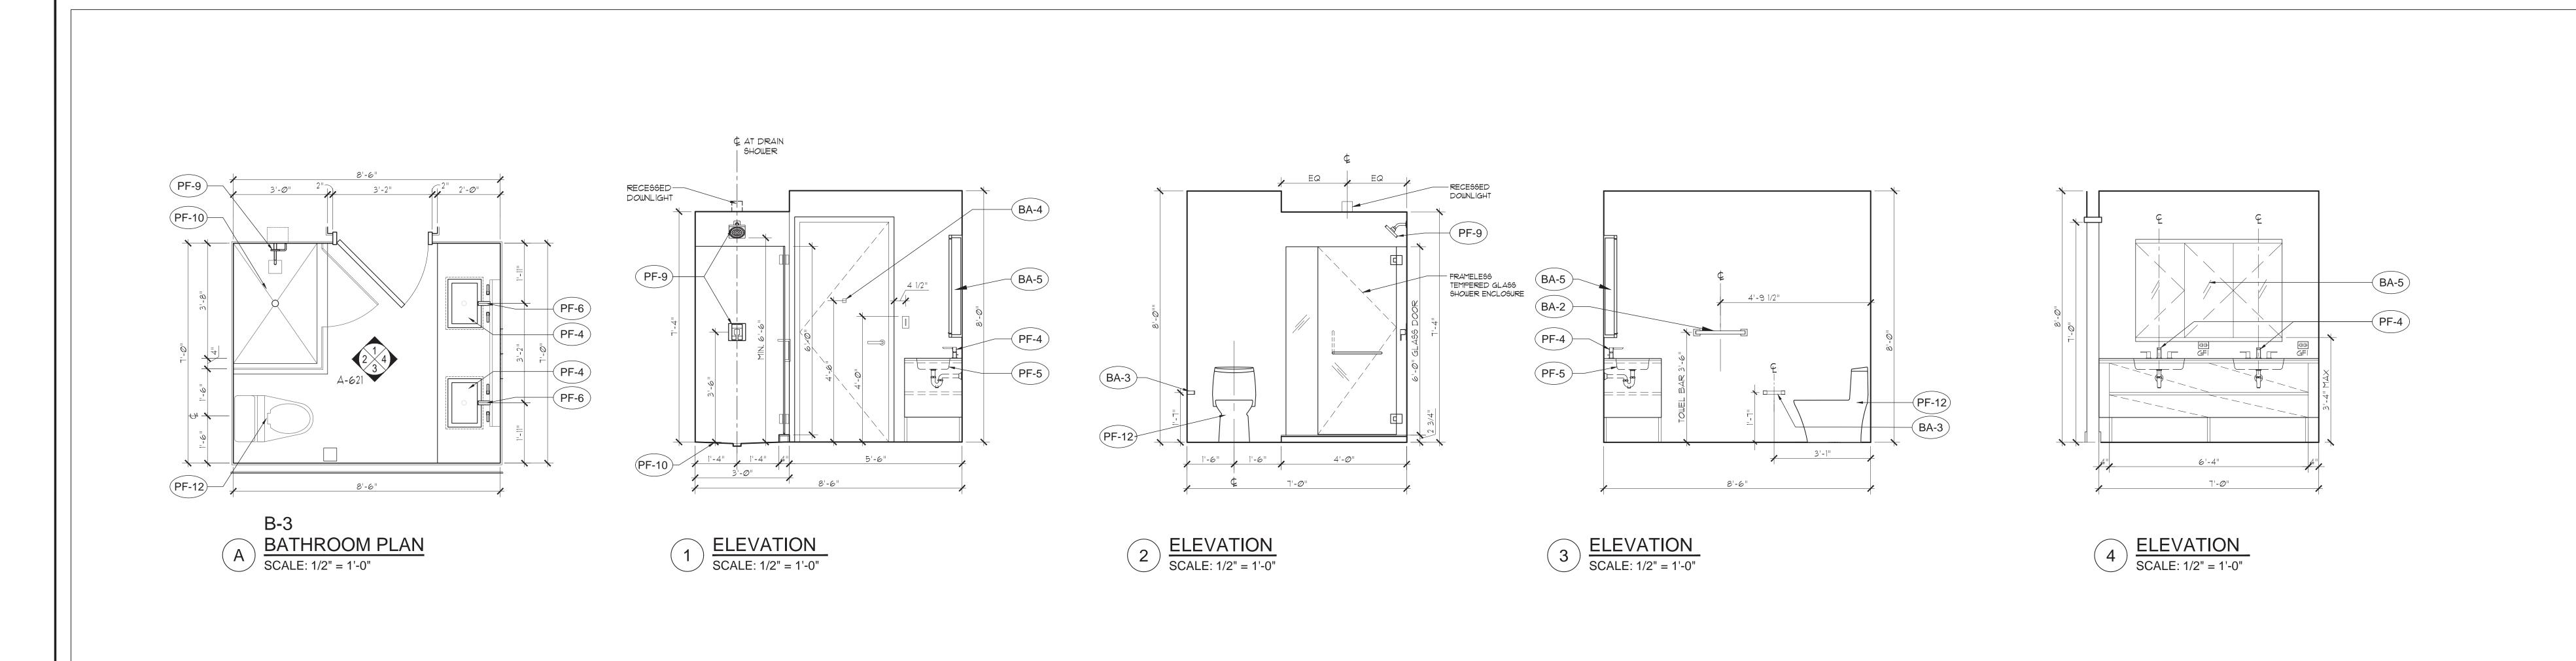

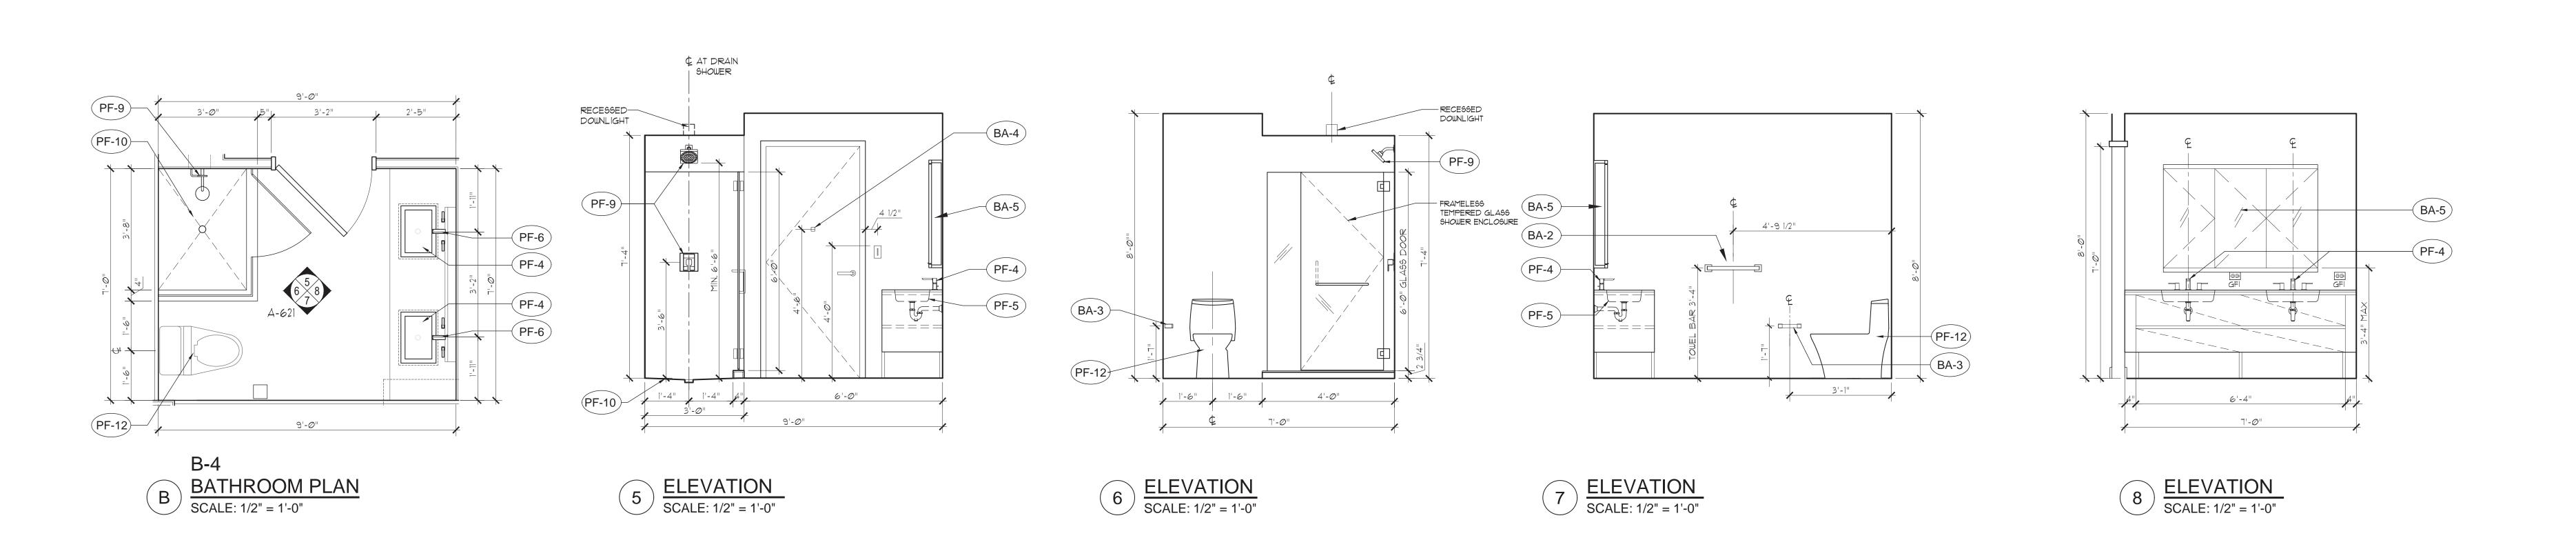

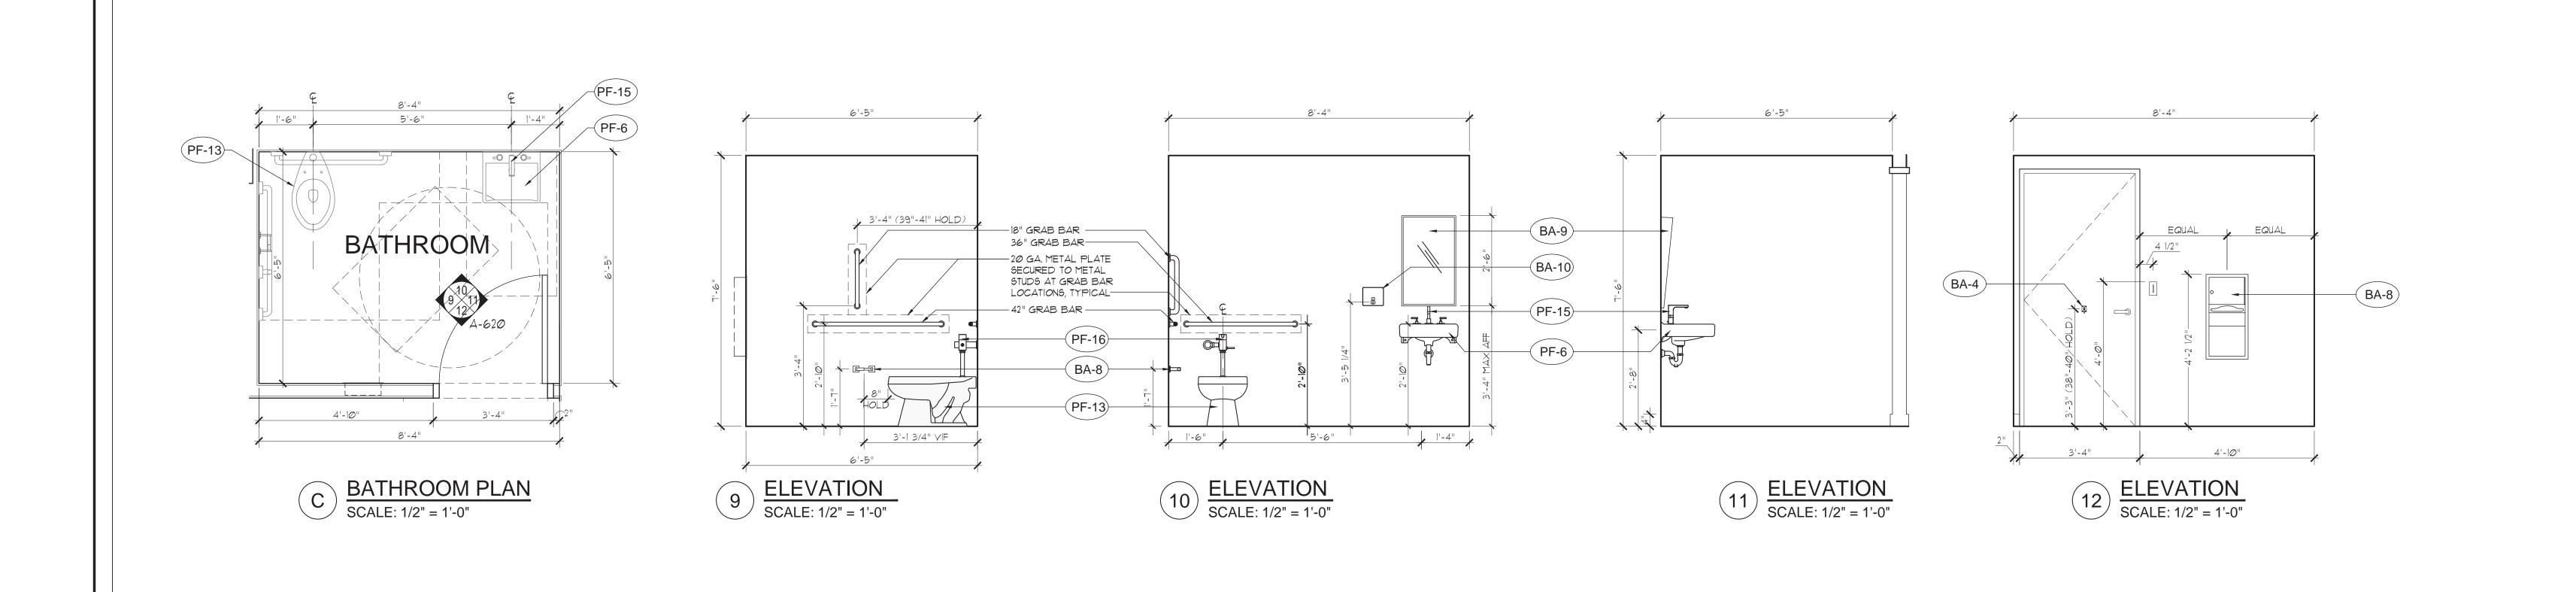

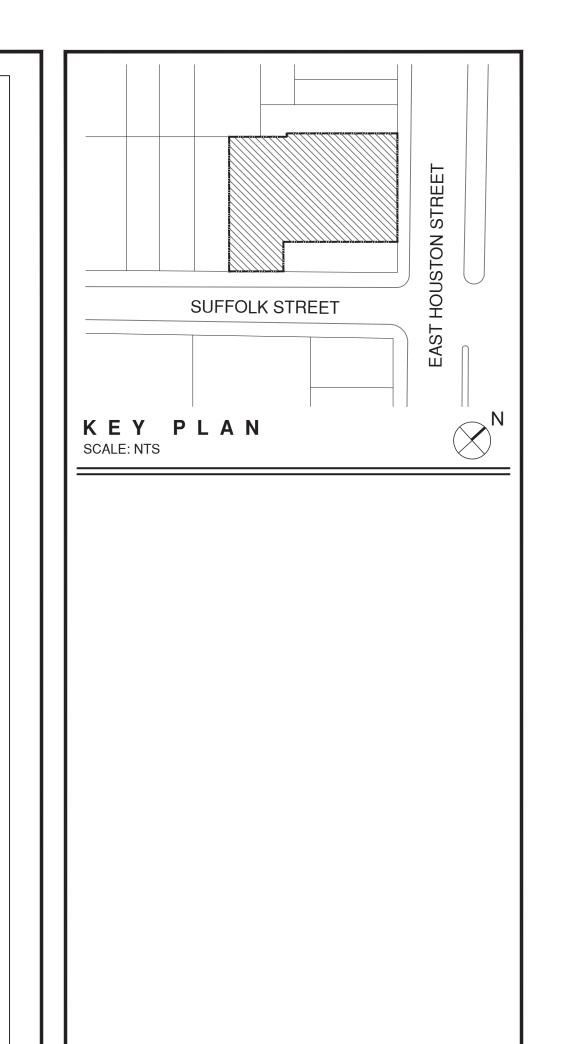

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New York, N.Y. 10016
212-421-3712

Andi Pepper Interior Design

Interior Designers
381 Park Avenue South
New York, N.Y. 10016
212-421-3712

McNamara-Salvia

Consulting Engineers (Structural Engineering)
62 West 45th Street
New York, N.Y. 10036
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R A Consultants LLC


Consulting Engineers (Support of Excavation) 512 7th Avenue New York, N.Y. 10018 646-484-3250

DOB# 121189711

255 EAST HOUSTON ST. MANHATTAN, N.Y. 10002

Drawing Title:

BATHROOM TYPES

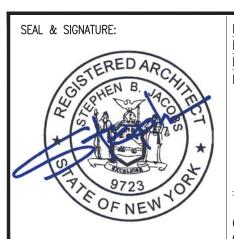

PROJECT#: 1446

DRAWING SCALE: AS NOTED

DRAWING NO:

A-621.00

CAD REF:

G:/1446 - A-620-621 - BATHROOM TYPES.dwg

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255 EAST HOUSTON ST, NEW YORK, NY 10002

SBJG PROJ. # 1446

	UNIT HEIGHT DISTRIBUTION CHART A														
FLOOR		INCLUSIONARY HOUSING APARTMENT NUMBERS													
	Α	В	С	D	Е	F	G	Н	J	K	L				
13												0			
12												0			
11												0			
10												0			
9						9F						1			
8	8A											1			
7	7A					7F						2			
6	6A						6G			6K		3			
5						5F			5J	5K		3			
4	4A					:	4G		4J		<u> </u>	3			
3							3G		3J	3K		3			
2	2A								2J			2			
1															
	TOTAL DU: 18														

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HORIZONTAL UNIT DISTRIBUTION CHART B													
FLOOR	MARKETING FLOOR #	TOTAL # OF UNITS PER FLOOR	IH UNITS PER FLOOR	STAFF UNITS PER FLOOR	NON-IH UNITS PER FLOOR	IH %-AGE							
1	1	0	0			0.00%							
2	2	9	2		7	22.22%							
3	3	10	3		7	30.00%							
4	4	10	3		7	30.00%							
5	5	10	3		7	30.00%							
6	6	10	3		7	30.00%							
7	7	10	2		8	20.00%							
8	8	7	1		6	14.29%							
9	9	6	1		5	16.67%							
10	10	4	0		4	0.00%							
11	11	4	0		4	0.00%							
12	12	4	0		4	0.00%							
13	PH	4	0		4	0.00%							
	TOTAL:	88	18		70								

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	UNIT BEDROOM MIX CHART C														
IH TYPES	UNIT SUMMARY	% BREAKDOWN	NON-IH UNIT TYPES	% BREAKDOWN	SUPER/STAFF UNITS	TOTAL NO. OF UNITS									
STUDIO	7	38.89%	30	42.86%	l	37									
1 BR.	8	44.44%	31	44.29%		39									
2 BR.	3	16.67%	8	11.43%		11									
3 BR.	0 0.00% 1 1.43%														
TOTAL:	18	100.00%	70		0	88									

architects • planners

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INCLUSIONARY HOUSING NET SF CHART

SBJG PROJ. # 1446

	UNI	IT A	UN	IT B	UN	IT C	UNI	IT D	UN	IT E	UNI	TF	UNI	T G	UNI [.]	ТН	UNI	ΤJ	UN	ΤK	UN	IT L	ABOVE	MECH. &		COMMUNITY	TOTAL	NET			LOW IN	COME UN	IIT INFO
FLOOR	NET SF	TYPE	NET SF	TYPE	NET SF	TYPE	NET SF	TYPE	NET SF	TYPE	NET SF	TYPE	NET SF	TYPE	NET SF	TYPE	NET SF	TYPE	NET SF	TYPE	NET SF	TYPE	GRADE GROSS SF/FL	STAIR DEDUCT.	Q.H. DEDUCT.	FACILITY FA	RES. ZONING FA [A]	MARKET UNIT FA [C]	NET UNIT SF PER FL	UNITS PER FL	FLOOR AREA [B]	UNIT CT/FL	UNIT % PER FL
CELLAR			 	 	<u> </u> 	<u> </u> 				 									 								<u> </u>						<u> </u>
1		∤ 		 	 	 			<u> </u>	 	 						 		 				8,638	67	1,409	4,510	2,652	↓ 			 		
2	592	1BR	361	STU	360	STU	702	1BR	599	1BR	606	1BR			416	STU	409	STU	1,007	2BR			7,198	323	781		6,093	4,051	5,052	9	1,001	2	22.22%
3	592	1BR	361	STU	360	STU	702	1BR	599	1BR	608	1BR	404	STU	415	STU	410	STU	1,006	2BR			7,625	345	781		6,500	3,637	5,457	10	1,820	3	30.00%
4	592	1BR	361	STU	360	STU	702	1BR	599	1BR	608	1BR	404	STU	415	STU	410	STU	1,006	2BR			7,625	345	781		6,500	4,051	5,457	10	1,406	3	30.00%
5	592	1BR	361	STU	360	STU	702	1BR	599	1BR	608	1BR	404	STU	415	STU	410	STU	1,006	2BR			7,625	345	781		6,500	3,433	5,457	10	2,024	3	30.00%
6	592	1BR	361	STU	360	STU	695	1BR	599	1BR	608	1BR	404	STU	415	STU	410	STU	1,006	2BR			7,659	345	781		6,534	3,448	5,450	10	2,002	3	30.00%
7	592	1BR	361	STU	360	STU	695	1BR	599	1BR	608	1BR	404	STU	415	STU	410	STU	1,006	2BR			7,659	345	781		6,534	4,250	5,450	10	1,200	2	20.00%
8	592	1BR	361	STU	360	STU	695	1BR	599	1BR	608	1BR				 	 			 	1,476	3BR	6,565	281	611		5,673	4,099	4,691	7	592	11	14.29%
9	592	1BR	360	STU	360	STU	695	1BR	599	1BR	608	1BR					 		 				4,614	203	421		3,990	2,606	3,214	6	608	11	16.67%
10	633	1BR	! ! ! 	! ! ! !	<u> </u>	<u> </u>	989	2BR	872	2BR	340	STU					 						4,258	220	421		3,617	2,834	2,834	4	0	0	0.00%
11	612	1BR	i 	i 	 		707	1BR	841	2BR	340	STU					i 		 				3,870	203	421		3,245	2,500	2,500	4	0	0	0.00%
12	612	1BR	! ! ! !	! ! ! !	 		707	1BR	841	2BR	340	STU					 		 				3,870	203	421		3,245	2,500	2,500	4	0	0	0.00%
13	612	1BR	i 	i 	 	 	707	1BR	841	2BR	340	STU					 		 				3,870	203	421		3,245	2,500	2,500	4	0	0	0.00%
14					<u> </u>	<u> </u>			į	<u> </u>													1,232	48	494		690	!			-		i
TOTAL:	7,205		2,887		2,880		8,698		8,187		6,222		2,020		2,491		2,459		6,037		1,476		82,306	3,474	9,306	4,510	65,016	39,909	50,562	88	10,653	18	20.45%

UNIT MIX

FLOOR	STUDIO	1BR	2BR	3BR	TOTALS
1					
2	4	4	1		9
3	5	4	1		10
4	5	4	1		10_
5	5_	_4	1		10_
6	5_	_4	1		10_
7	5_	_4	1		10_
8	2_	_4		_ 1_	7_
9	2_	_4	 		6_
10	1	1	2		4
11	1	2	1		4
12	1	2	1		4
13	1	2	1		4
TOTAL:	37	39	11	1	88

PERCENTAGE: 42.05% 44.32% 12.50% 1.14% 100.00%

